

# YORK COUNTY PRISON HVAC RENOVATIONS 778 JUSTICE BOULEVARD YORK, SOUTH CAROLINA 29745

## AUGUST 18, 2023

Principal in Charge: DER JEB/DER  
Project Engineer: JEB LAM  
Drawn By: JEB

Revisions:  
No. | Date | Description

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**SOUTH CAROLINA**  
BUFORD GOFF & ASSOCIATES, INC.  
No. 000022  
CERTIFICATE OF AUTHORIZATION

**SOUTH CAROLINA**  
LICENSED PROFESSIONAL ENGINEER  
No. 26527  
08/18/2023  
LONN THAN BURKET

**MECHANICAL - ELECTRICAL - PLUMBING**

**BUFORD GOFF & ASSOCIATES, INC.**  
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YORK COUNTY PRISON  
HVAC RENOVATIONS  
COVER SHEET

### CODE ANALYSIS

- INTERNATIONAL BUILDING CODE (IBC): 2021
- INTERNATIONAL FIRE CODE (IFC): 2021
- INTERNATIONAL FUEL CODE (IFC): 2021
- INTERNATIONAL MECHANICAL CODE (IMC): 2021
- INTERNATIONAL PLUMBING CODE (IPC): 2021
- NATIONAL ELECTRIC CODE (NEC): 2020
- INTERNATIONAL ENERGY CONSERVATION CODE (IECC): 2009  
ALTERNATE COMPLIANCE WITH ASHRAE 90.1 (2007)
- SEISMIC & WIND DESIGN CRITERIA: CATEGORY B,  
OCCUPANCY III, WIND SPEED 120 MPH



### DRAWING INDEX

**GENERAL CONSTRUCTION**


GC-101 General Construction Plan - Renovation

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- M-002 AREA B - HVAC DEMOLITION
- M-003 AREA C - HVAC DEMOLITION
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- M-102 AREA B - HVAC RENOVATION
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- M-301 HVAC SCHEDULES (EXISTING)
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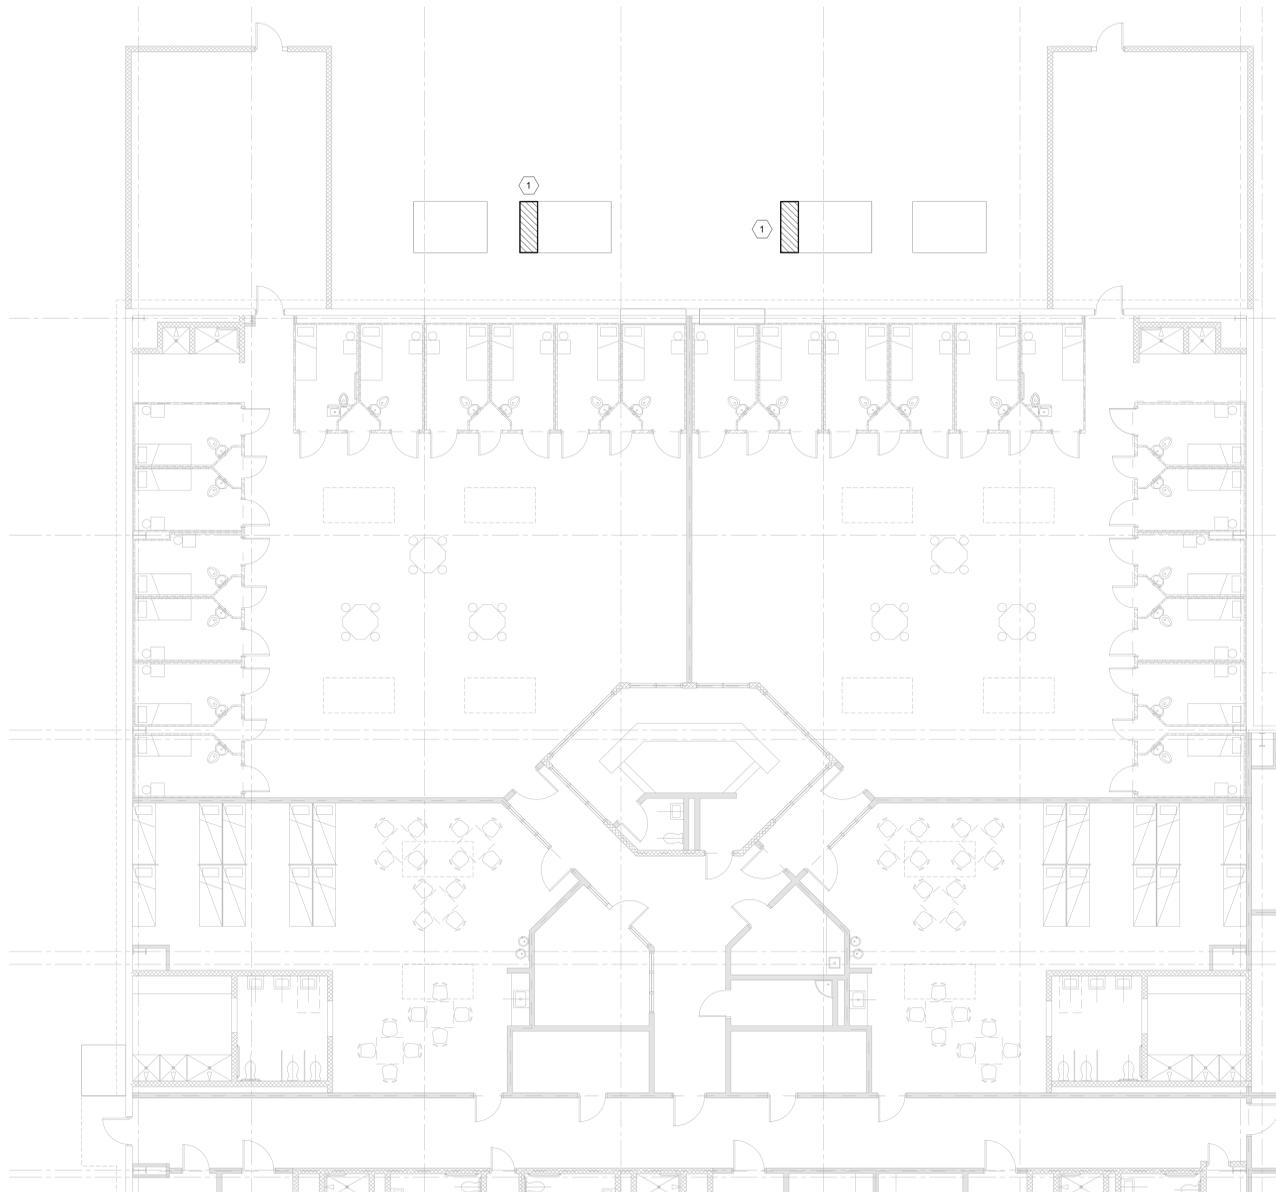


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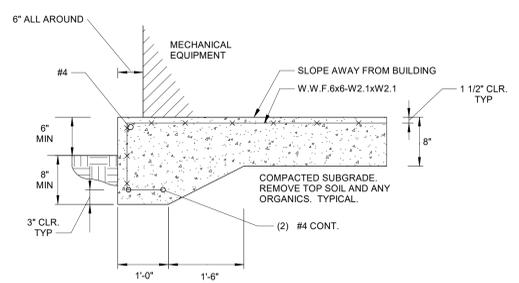
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**CS**

Date: 08-18-2023  
Scale: As Noted  
BGA Project Number: 22031  
CONSTRUCTION DOCUMENTS

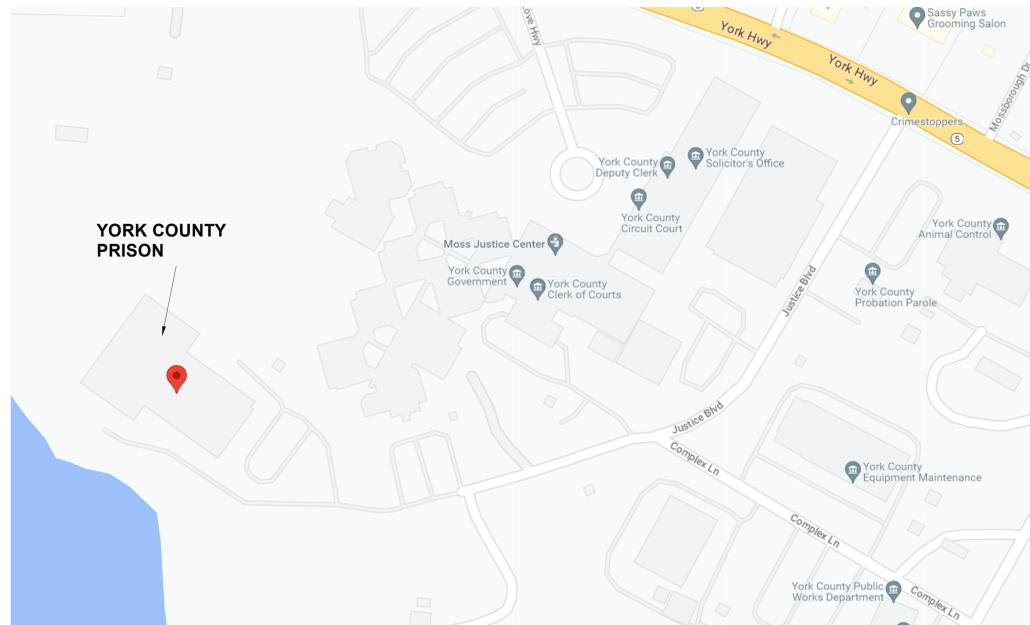

**1** AREA A - GENERAL CONSTRUCTION PLAN  
1/8" = 1'-0"



- NOTES:
1. EXTEND THE TOE FOOTING DEPTH TO ENSURE LEVEL PAD AND EQUIPMENT AND ADJUST FOR GRADES.

**EQUIPMENT PAD DETAIL**  
NOT TO SCALE

**GENERAL NOTES:**

1. CONTRACTOR TO FIELD VERIFY EXISTING CONDITIONS PRIOR TO ORDERING EQUIPMENT.

**# GENERAL CONSTRUCTION KEYNOTES:**

1. EXTEND EXISTING PAD AS REQUIRED FOR NEW UNIT.


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Project Engineer: JEB  
Drawn By: JEB

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YORK COUNTY PRISON  
HVAC RENOVATIONS  
AREA A - GENERAL CONSTRUCTION PLAN




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CONSTRUCTION DOCUMENTS

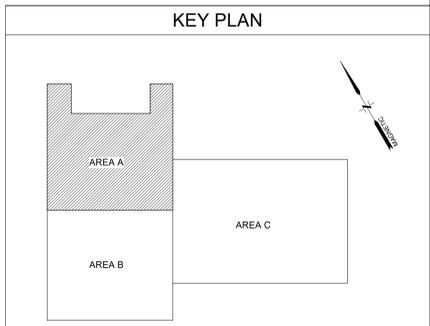

1 AREA A - HVAC DEMOLITION  
1/8" = 1'-0"

**GENERAL HVAC DEMOLITION NOTES**

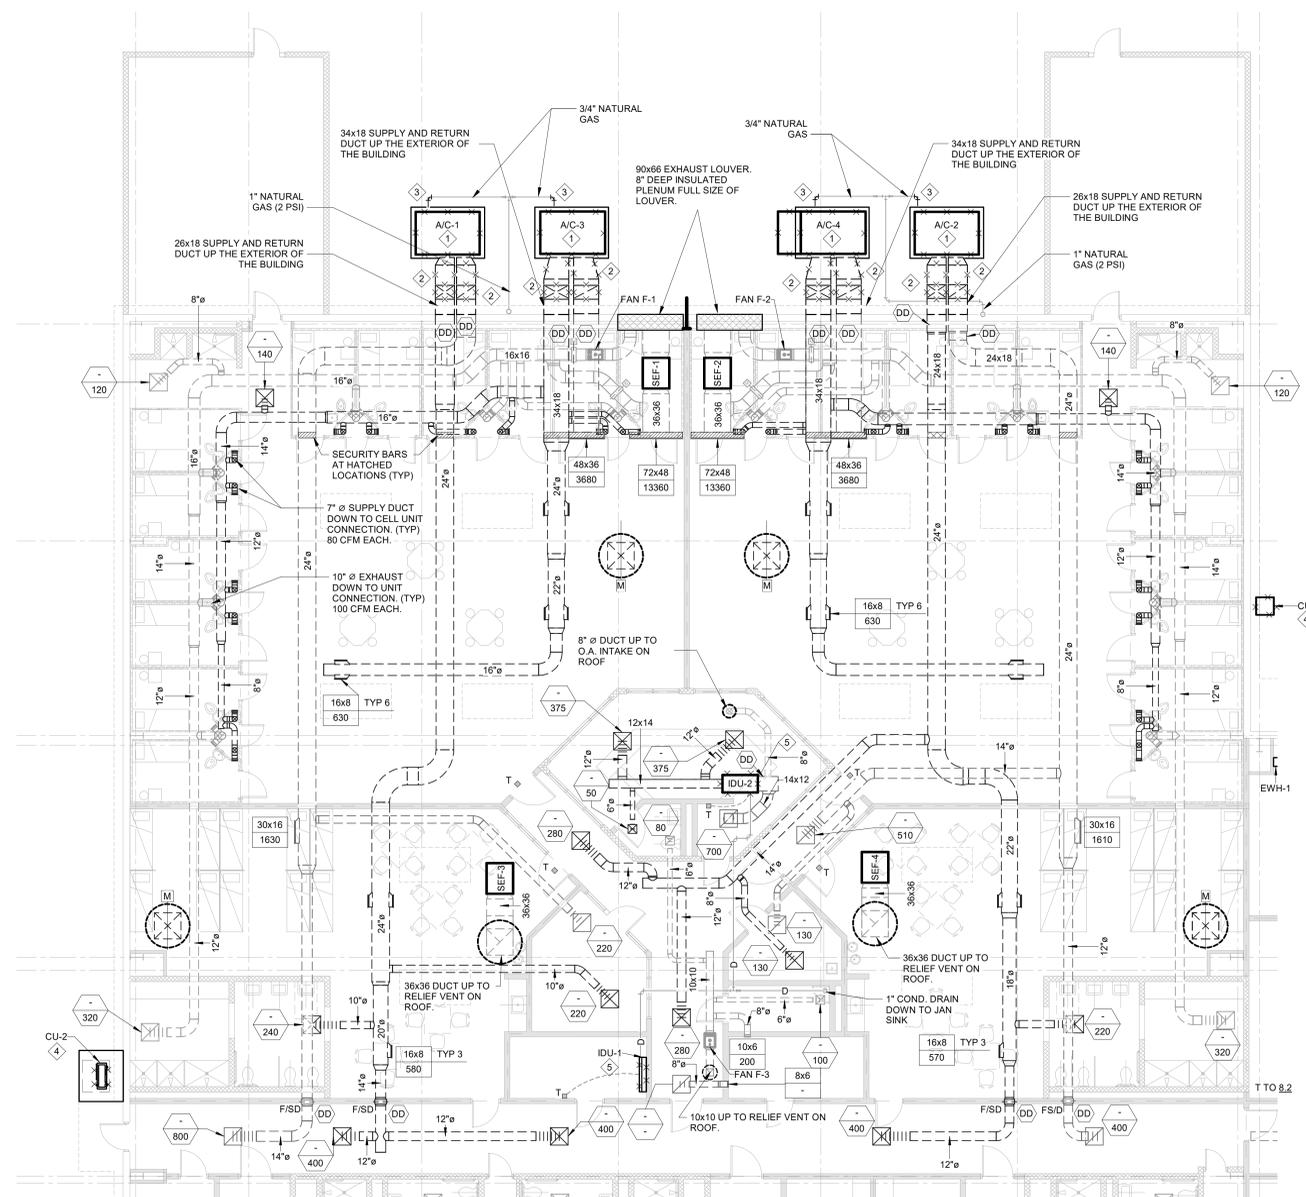- DRAWINGS SHOW GENERAL INTENT OF DEMOLITION. QUANTITIES, LOCATIONS, SIZES AND EQUIPMENT ARE SHOWN TO INDICATE TYPE OF SYSTEM INSTALLED AND DOES NOT NECESSARILY REPRESENT EXACT CONDITIONS. CONTRACTOR SHALL FIELD VERIFY BEFORE BIDDING.
- DEMOLITION OF EQUIPMENT, SYSTEMS, AND COMPONENTS SHALL INCLUDE ALL SUPPORTS, PADS, HANGERS, INSULATION, CONTROLS, STARTERS, ACCESSORIES, AND APPURTENANCES NOT REQUIRED FOR THE INSTALLATION OF THE NEW SYSTEM.
- PATCHING OF BUILDING STRUCTURES AND FINISHES SHALL PERTAIN TO ALL WALLS, FLOORS, SLABS, ROOFS, STRUCTURES, AND FINISHES. PATCHES SHALL MATCH EXISTING STRUCTURE, FIRE RATING AND FINISH.
- ALL OPENINGS CREATED BY THE ABANDONMENT OR REMOVAL OF EXISTING SYSTEMS SHALL BE PATCHED.
- ALL WALL, ROOFS, SLABS, STRUCTURES AND FINISHES WHOSE FINISH IS IRREGULAR DUE TO THE REMOVAL OF SYSTEMS, SUPPORTS, PADS, ACCESSORIES AND APPURTENANCES SHALL BE PATCHED.
- ALL FINISHES SHALL MATCH EXISTING FINISH. WHEN FINISH OBVIOUSLY DOES NOT MATCH EXISTING FINISH SUCH AS SHADE OF PAINT, AGE OF FINISH, ETC., THE FINISH SHALL BE APPLIED TO THE PATCH AND THE SURFACE IN ALL DIRECTIONS UNTIL A SURFACE CHANGE OF A MINIMUM 45 DEGREE.
- REMOVAL OF SYSTEMS SHALL INCLUDE COMPLETE SYSTEM WHENEVER PRACTICAL. IF NOT, SYSTEM (PIPE, CONDUIT, ETC.) SHALL BE REMOVED TO 1 INCH BELOW SURFACE.

**HVAC DEMOLITION KEYNOTES**

- DEMOLISH EXISTING GRADE MOUNTED GAS PACK UNITS.
- DEMOLISH DUCTWORK BACK TO BUILDING.
- DEMOLISH GAS PIPING BACK PAST THE EXISTING REGULATOR.
- DEMOLISH EXISTING CONDENSING UNIT AND ASSOCIATED REFRIGERANT PIPING BACK TO INDOOR UNIT.
- DEMOLISH INDOOR AHU AND DUCTWORK AS REQUIRED FOR NEW UNIT.

Principal in Charge: DER

Project Engineer: JEB

Drawn By: JEB

Revisions:

No.	Date	Description


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HVAC RENOVATIONS  
AREA A - HVAC DEMOLITION


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**M-001**

Date: 08-18-2023  
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CONSTRUCTION DOCUMENTS



1 AREA B - HVAC DEMOLITION  
1/8" = 1'-0"

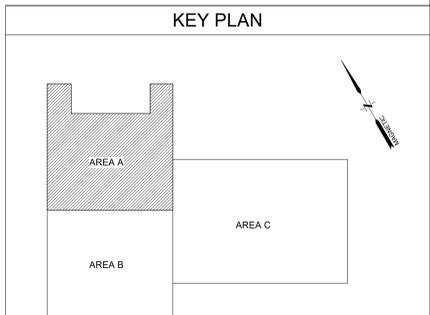**GENERAL HVAC DEMOLITION NOTES**
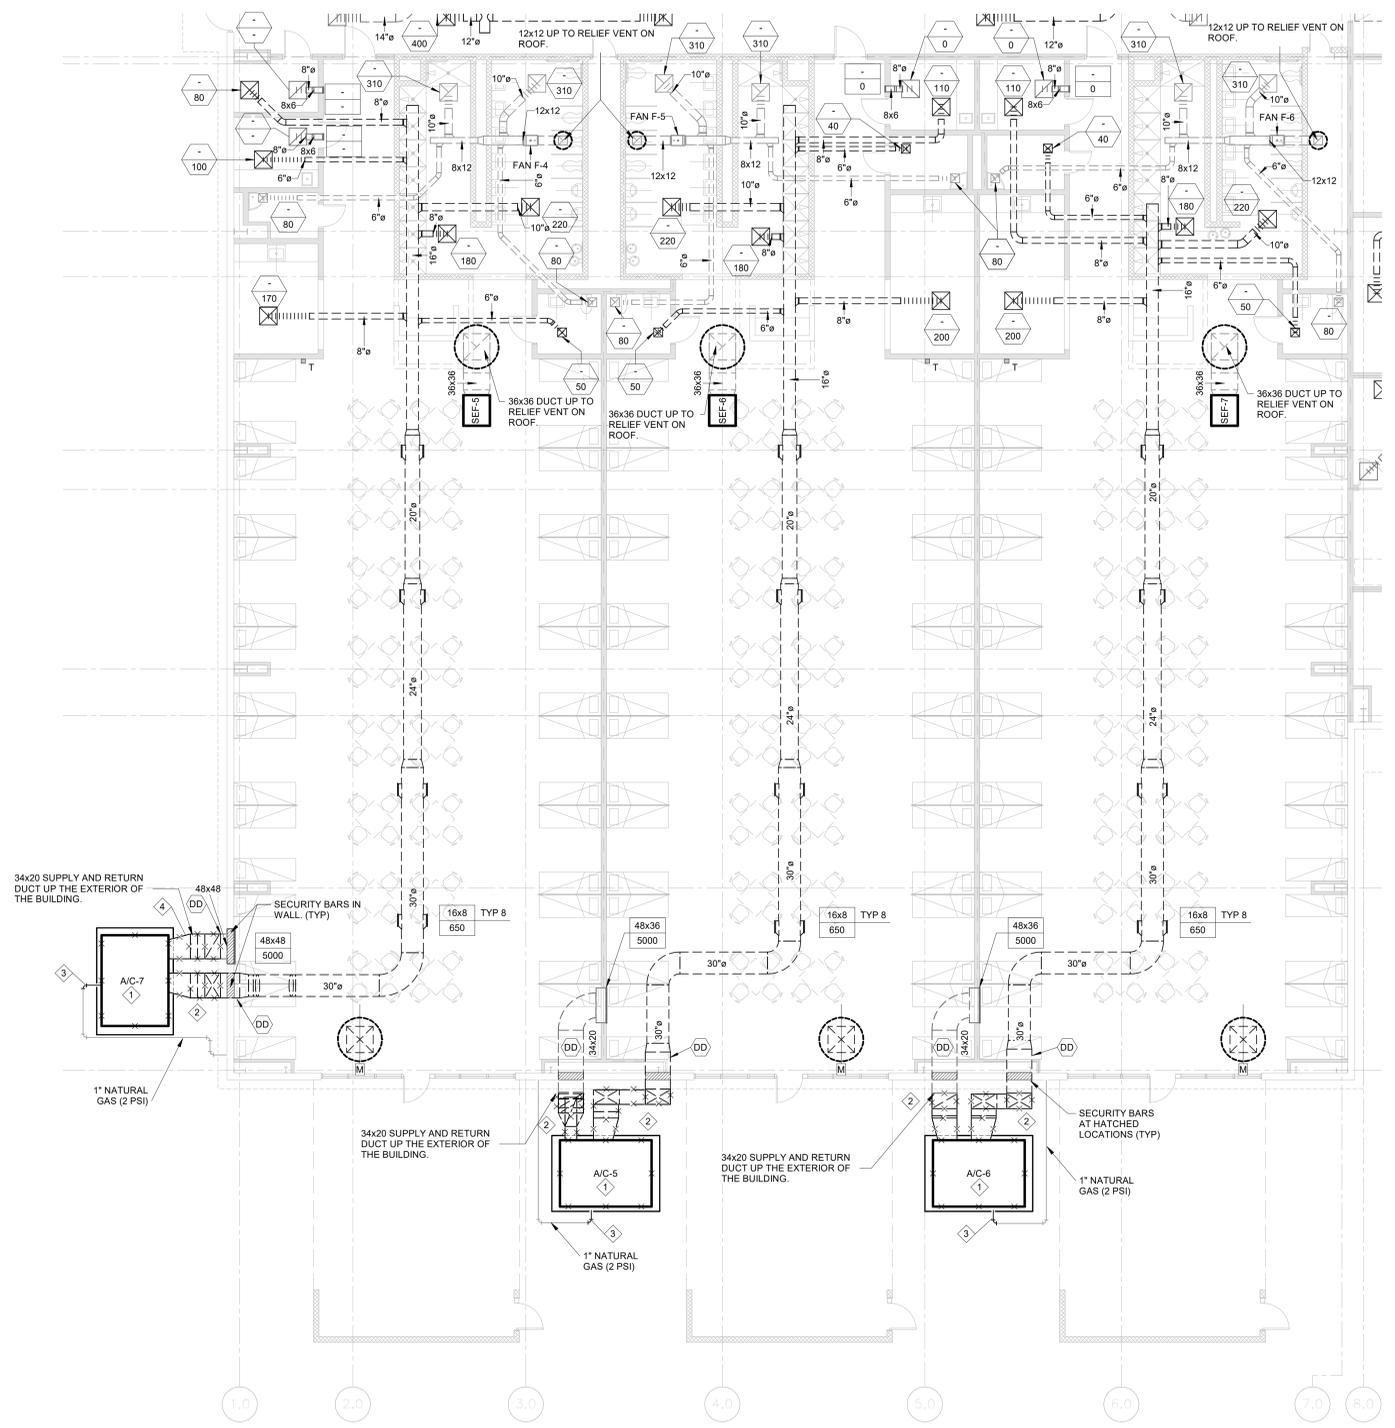
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**HVAC DEMOLITION KEYNOTES**

- DEMOLISH EXISTING GRADE MOUNTED GAS PACK UNITS.
- DEMOLISH DUCTWORK BACK TO BUILDING.
- DEMOLISH GAS PIPING BACK PAST THE EXISTING REGULATOR.
- DEMOLISH DUCTWORK UP TO ELBOW. DO NOT DEMOLISH DUCT DETECTOR.

Principal in Charge: DER

Project Engineer: JEB

Drawn By: JEB

Revisions:

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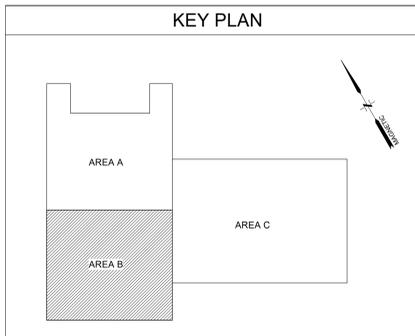
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YORK COUNTY PRISON  
HVAC RENOVATIONS  
AREA B - HVAC DEMOLITION

Project Title:

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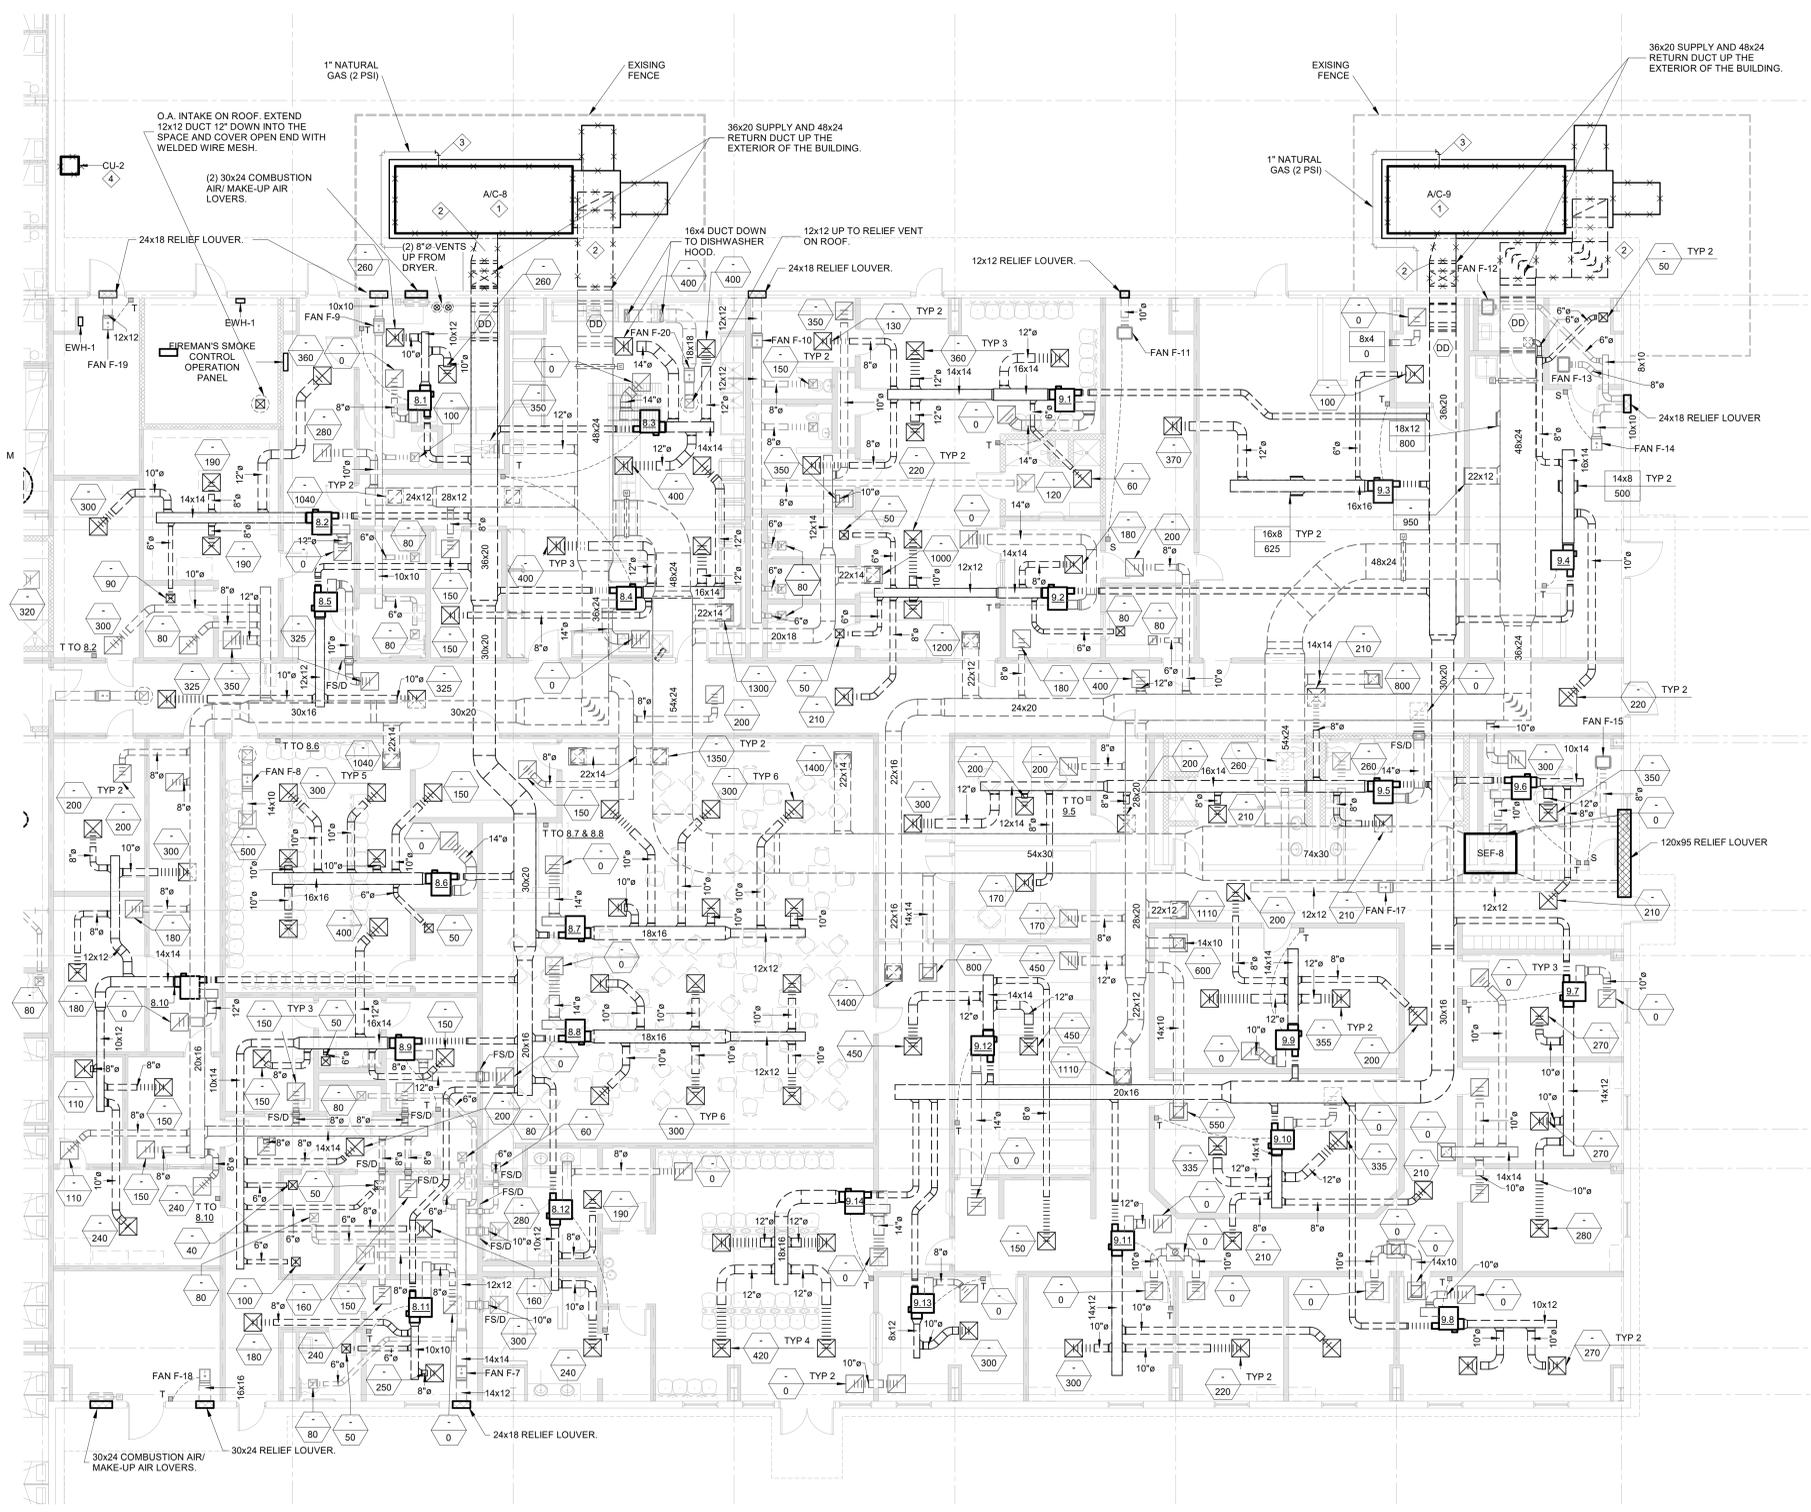


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**M-002**

Date: 08-18-2023  
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BGA Project Number: 22031  
CONSTRUCTION DOCUMENTS



1 AREA C - HVAC DEMOLITION  
1/8" = 1'-0"

**GENERAL HVAC DEMOLITION NOTES**

- DRAWINGS SHOW GENERAL INTENT OF DEMOLITION. QUANTITIES, LOCATIONS, SIZES AND EQUIPMENT ARE SHOWN TO INDICATE TYPE OF SYSTEM INSTALLED AND DOES NOT NECESSARILY REPRESENT EXACT CONDITIONS. CONTRACTOR SHALL FIELD VERIFY BEFORE BIDDING.
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**HVAC DEMOLITION KEYNOTES**

- DEMOLISH EXISTING GRADE MOUNTED GAS PACK UNITS.
- DEMOLISH DUCTWORK BACK TO BUILDING.
- DEMOLISH GAS PIPING BACK PAST THE EXISTING REGULATOR.
- DEMOLISH EXISTING CONDENSING UNIT AND ASSOCIATED REFRIGERANT PIPING BACK TO INDOOR UNIT.

Principal in Charge: DER

Project Engineer: JEB

Drawn By: JEB

Revisions:


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HVAC RENOVATIONS  
AREA C - HVAC DEMOLITION


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Sheet Number:  
**M-003**

Date: 08-18-2023  
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BGA Project Number: 22031  
CONSTRUCTION DOCUMENTS



1 AREA A - HVAC RENOVATION  
1/8" = 1'-0"

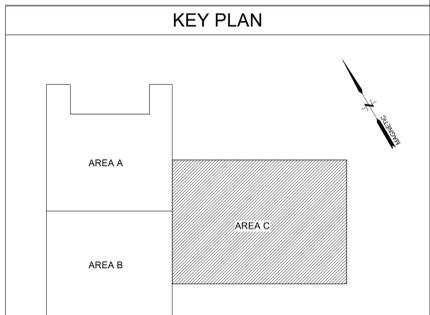- GENERAL NOTES:**
- CONTRACTOR TO VERIFY EXISTING CONDITIONS PRIOR TO ORDERING EQUIPMENT.
  - COORDINATE PLACEMENT OF NEW UNITS AND DUCTWORK WITH EXISTING CONDITIONS.
  - FIELD VERIFY EXISTING DUCT SIZES.
  - CONTRACTOR TO REBALANCE THE SYSTEM TO DESIGN CFMS.
  - CONTRACTOR TO TEST ALL EXISTING DUCT DETECTORS TO VERIFY THAT THEY ARE FUNCTIONING CORRECTLY.
- HVAC KEYNOTES:**
- INSTALL NEW PACKAGED UNIT ON EXISTING PAD.
  - ROUTE DUAL WALL DUCTWORK UP THE EXTERIOR WALL AND CONNECT TO EXISTING OPENING.
  - RECONNECT THE NEW CONDENSATE DRAINS TO THE EXISTING DRAIN SYSTEM.
  - CONNECT NEW UNIT TO EXISTING GAS LINE. PROVIDE NEW REGULATOR, SHUTOFF VALVE AND GAUGES. SEE DETAIL.
  - INSTALL NEW CONDENSING UNIT ON EXISTING PAD.
  - ROUTE REFRIGERANT PIPING FROM ASSOCIATED CONDENSING UNIT TO CORRESPONDING INDOOR UNIT. REUSE EXISTING WALL OPENING AND FOLLOW THE SAME ROUTING.
  - INSTALL NEW INDOOR UNIT IN THE SAME APPROXIMATE LOCATION AS THE EXISTING UNIT.
  - VERIFY EXISTING DUCT DETECTOR IS WORKING PROPERLY. CONTRACTOR SHALL CONNECT NEW EQUIPMENT TO EXISTING DETECTORS FOR SHUTDOWN. SEE SEQUENCE FOR ADDITIONAL INFORMATION.
  - INSTALL NEW COMBINATION TEMPERATURE/HUMIDITY SENSOR IN THE SAME LOCATION AS THE EXISTING.

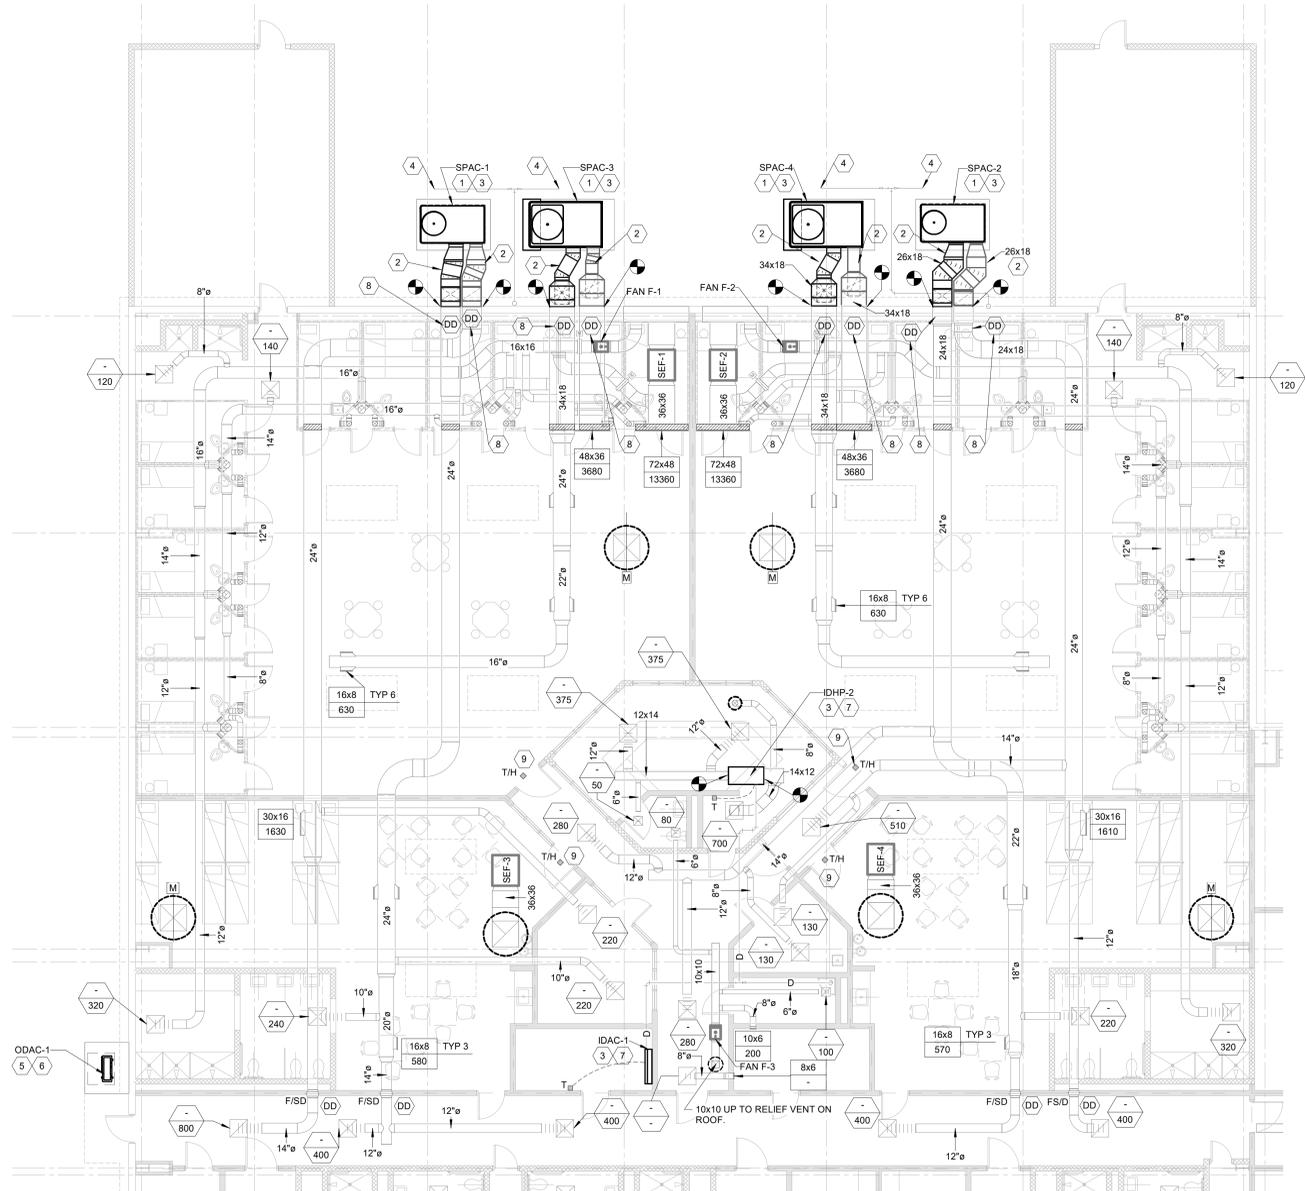Principal in Charge: DER

Project Engineer: JEB

Drawn By: JEB

Revisions:

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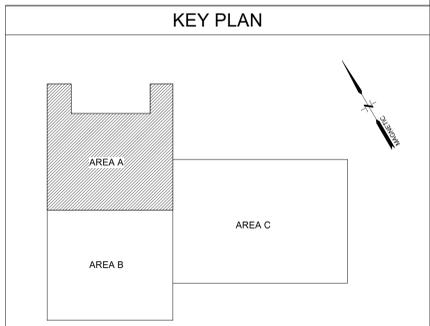
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YORK COUNTY PRISON  
HVAC RENOVATIONS  
AREA A - HVAC RENOVATION

Project Title:

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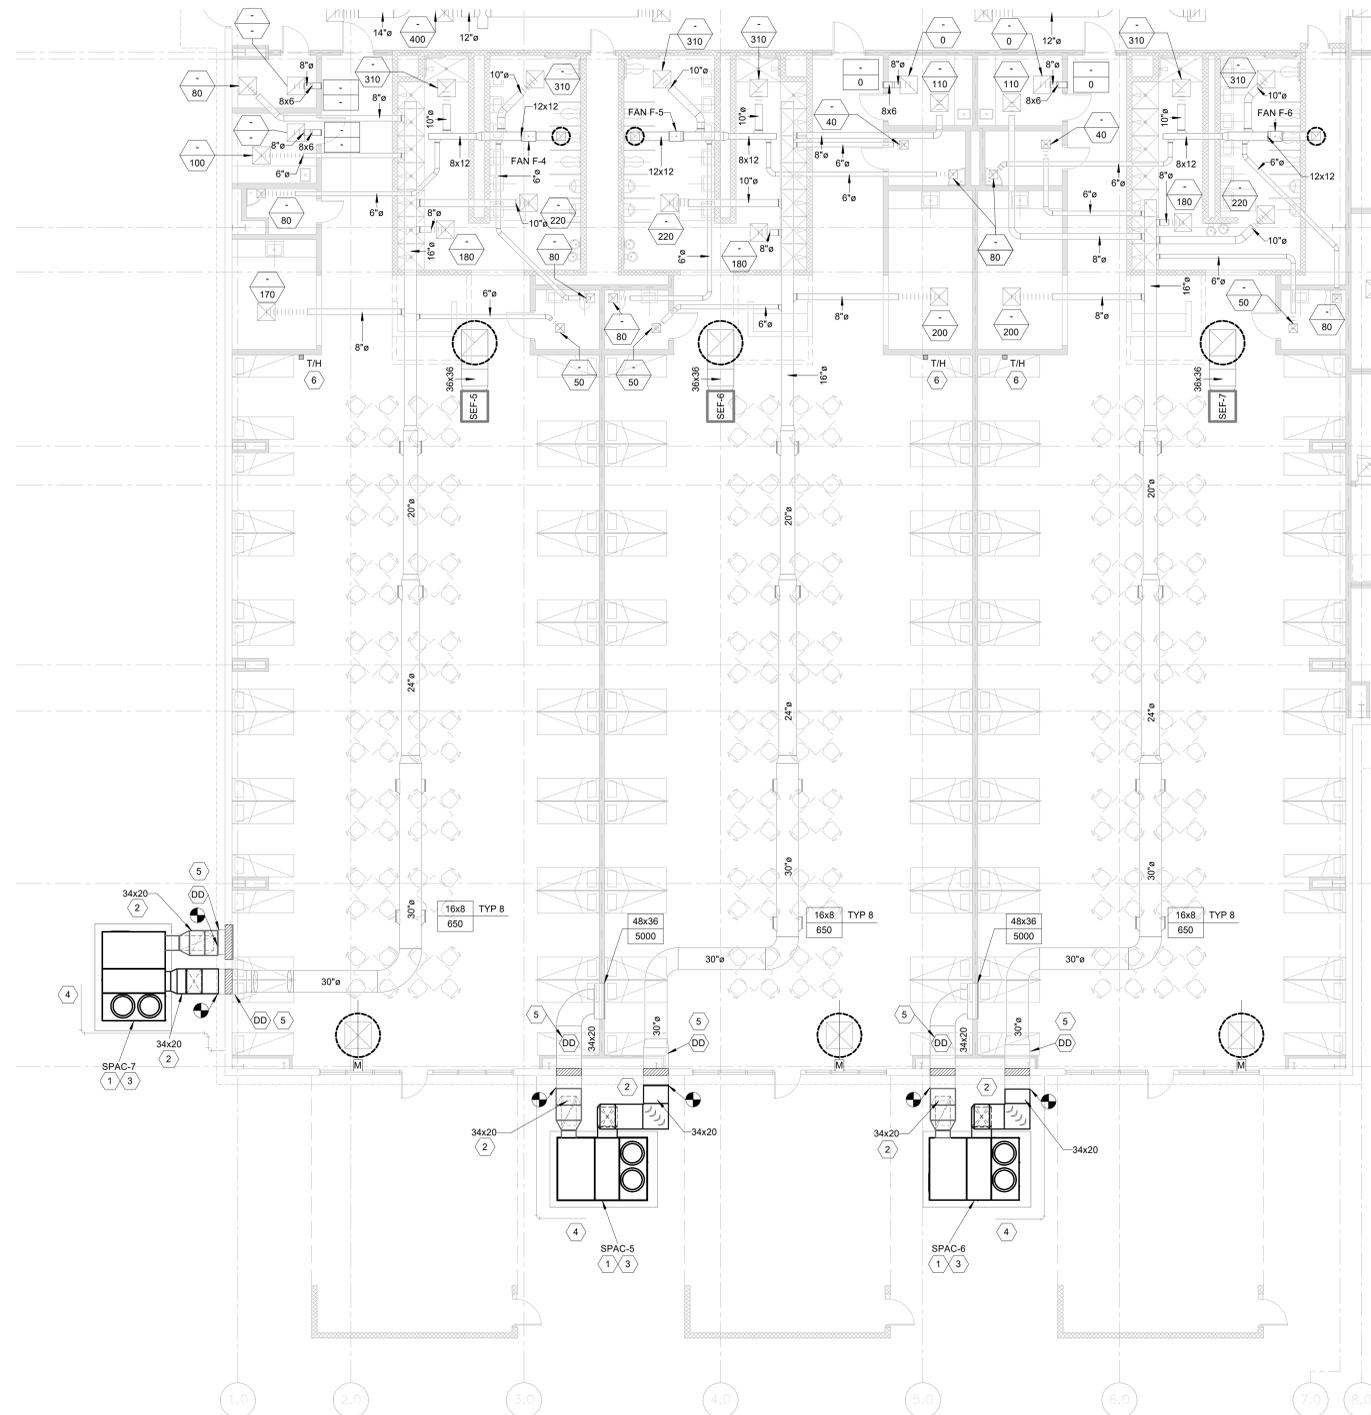


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**M-101**

Date: 08-18-2023  
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BGA Project Number: 22031  
CONSTRUCTION DOCUMENTS



1 AREA B - HVAC RENOVATION  
1/8" = 1'-0"

**GENERAL NOTES:**

- CONTRACTOR TO VERIFY EXISTING CONDITIONS PRIOR TO ORDERING EQUIPMENT.
- COORDINATE PLACEMENT OF NEW UNITS AND DUCTWORK WITH EXISTING CONDITIONS.
- FIELD VERIFY EXISTING DUCT SIZES.
- CONTRACTOR TO REBALANCE THE SYSTEM TO DESIGN CFMS.
- CONTRACTOR TO TEST ALL EXISTING DUCT DETECTORS TO VERIFY THAT THEY ARE FUNCTIONING CORRECTLY.

**# HVAC KEYNOTES:**

- INSTALL NEW PACKAGED UNIT ON EXISTING PAD.
- ROUTE DUAL WALL DUCTWORK UP THE EXTERIOR WALL AND CONNECT TO EXISTING OPENING.
- RECONNECT THE NEW CONDENSATE DRAINS TO THE EXISTING DRAIN SYSTEM.
- CONNECT NEW UNIT TO EXISTING GAS LINE. PROVIDE NEW REGULATOR, SHUTOFF VALVE AND GAUGES. SEE DETAIL.
- VERIFY EXISTING DUCT DETECTOR IS WORKING PROPERLY. CONTRACTOR SHALL CONNECT NEW EQUIPMENT TO EXISTING DETECTORS FOR SHUTDOWN. SEE SEQUENCE FOR ADDITIONAL INFORMATION.
- INSTALL NEW COMBINATION TEMPERATURE/HUMIDITY SENSOR IN THE SAME LOCATION AS THE EXISTING.

Principal in Charge: DER

Project Engineer: JEB

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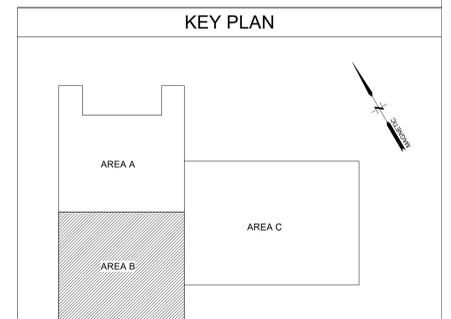


YORK COUNTY PRISON  
HVAC RENOVATIONS  
AREA B - HVAC RENOVATION

Project Title:

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**KEY PLAN**




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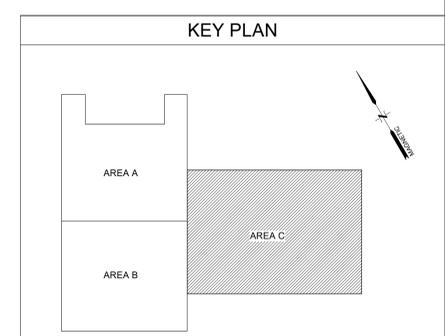
**M-102**

Date: 08-18-2023  
Scale: As Noted  
BGA Project Number: 22031  
CONSTRUCTION DOCUMENTS



1 AREA C - HVAC RENOVATION  
1/8" = 1'-0"

- GENERAL NOTES:**
- CONTRACTOR TO VERIFY EXISTING CONDITIONS PRIOR TO ORDERING EQUIPMENT.
  - COORDINATE PLACEMENT OF NEW UNITS AND DUCTWORK WITH EXISTING CONDITIONS.
  - FIELD VERIFY EXISTING DUCT SIZES.
  - CONTRACTOR TO REBALANCE THE SYSTEM TO DESIGN CFMS.
  - CONTRACTOR TO TEST ALL EXISTING DUCT DETECTORS TO VERIFY THAT THEY ARE FUNCTIONING CORRECTLY.
- # HVAC KEYNOTES:**
- INSTALL NEW PACKAGED UNIT ON EXISTING PAD.
  - ROUTE DUAL WALL DUCTWORK UP THE EXTERIOR WALL AND CONNECT TO EXISTING OPENING.
  - RECONNECT THE NEW CONDENSATE DRAINS TO THE EXISTING DRAIN SYSTEM.
  - CONNECT NEW UNIT TO EXISTING GAS LINE. PROVIDE NEW REGULATOR, SHUTOFF VALVE AND GAUGES. SEE DETAIL.
  - INSTALL NEW CONDENSING UNIT ON EXISTING PAD.
  - ROUTE REFRIGERANT PIPING FROM ASSOCIATED CONDENSING UNIT TO CORRESPONDING INDOOR UNIT. REUSE EXISTING WALL OPENINGS AND FOLLOW THE SAME ROUTING.
  - VERIFY EXISTING DUCT DETECTOR IS WORKING PROPERLY. CONTRACTOR SHALL CONNECT NEW EQUIPMENT TO EXISTING DETECTORS FOR SHUTDOWN. SEE SEQUENCE FOR ADDITIONAL INFORMATION.
  - INSTALL NEW COMBINATION TEMPERATURE/HUMIDITY SENSOR IN THE SAME LOCATION AS THE EXISTING.

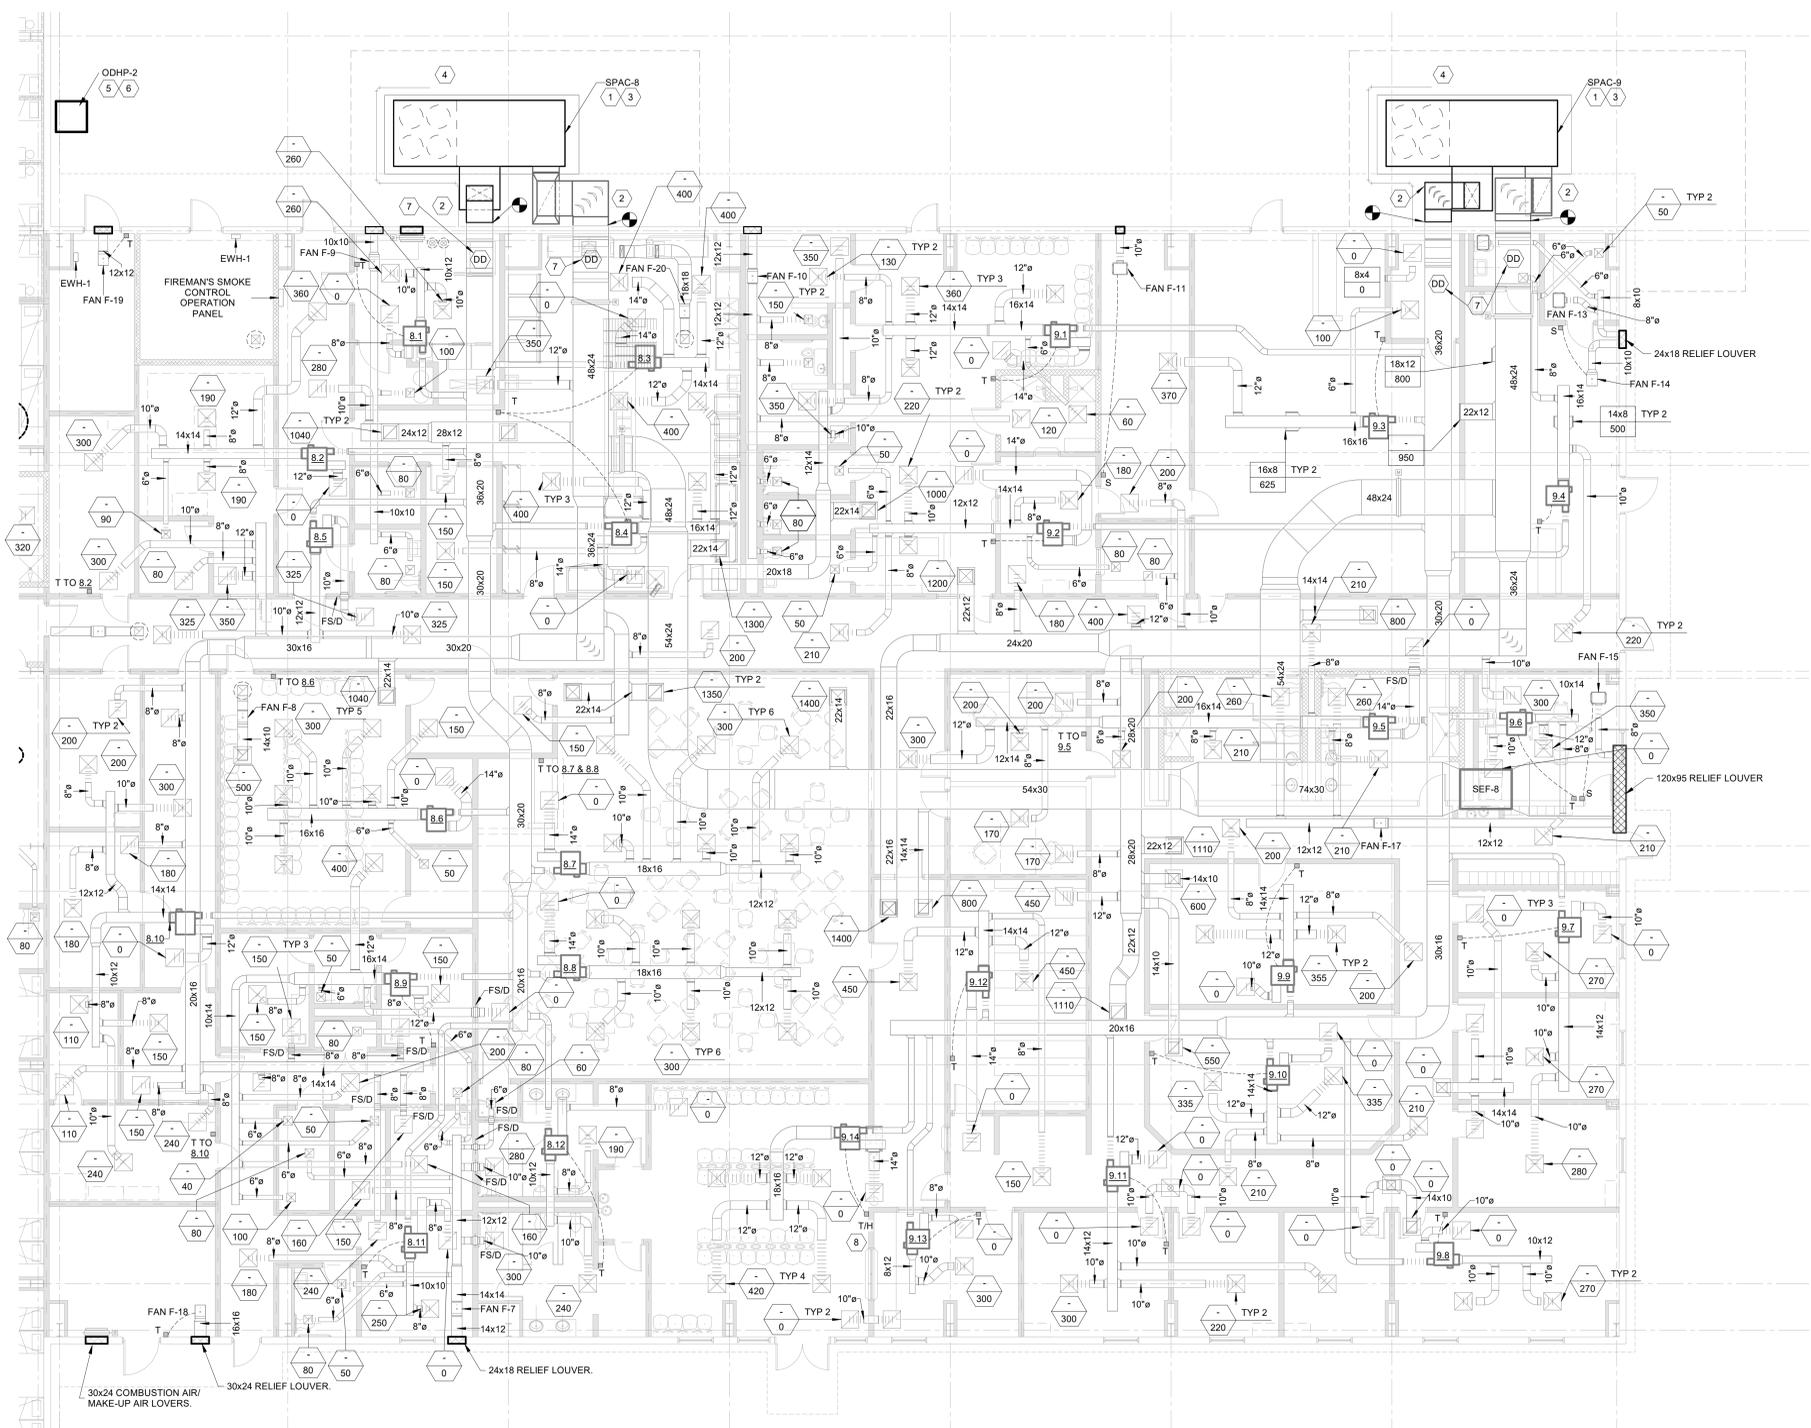

Principal in Charge: DER

Project Engineer: JEB

Drawn By: JEB

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**YORK COUNTY PRISON  
HVAC RENOVATIONS  
AREA C - HVAC RENOVATION**

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Sheet Number:  
**M-103**

Date: 08-18-2023  
Scale: As Noted  
BGA Project Number: 22031  
CONSTRUCTION DOCUMENTS

PARALLEL FAN POWERED AIR TERMINAL UNIT SCHEDULE (EXISTING SCHEDULE)																		
TERMINAL #	PRIMARY AIR		UNIT PD (a)	FAN SIDE			REHEAT COIL			NC LEVELS		DUJCT INLET	MAX WEIGHT (#)	ELECTRICAL			MANUFACTURER AND MODEL	REMARKS
	CFM MAX	CFM MIN		CFM	ESP (a)	HP	ELECT VOLT / PH	AIR ENT T	LVG T	ELECTRICAL KW	VOLT/PH			RAD.	DISCH.	MCA		
8.1	520	130	-	210	-	1/8	-	-	3.5	-	-	-	-	16.67	20	277/1		
8.2	1100	280	-	445	-	1/3	-	-	7.0	-	-	-	-	12.52	15	480/3		
8.3	1200	300	-	480	-	1/3	-	-	7.5	-	-	-	-	13.28	15	480/3		
8.4	1350	340	-	540	-	1/3	-	-	9.0	-	-	-	-	15.53	20	480/3		
8.5	650	165	-	260	-	1/8	-	-	4.5	-	-	-	-	21.18	25	277/1		
8.6	1600	320	-	640	-	1/3	-	-	10.0	-	-	-	-	17.04	20	480/3		
8.7	1800	360	-	720	-	1/3	-	-	11.0	-	-	-	-	19.05	20	480/3		
8.8	1800	360	-	720	-	1/3	-	-	11.0	-	-	-	-	19.05	20	480/3		
8.9	1300	325	-	520	-	1/3	-	-	7.5	-	-	-	-	13.28	15	480/3		
8.10	1200	300	-	480	-	1/3	-	-	7.5	-	-	-	-	13.28	15	480/3		
8.11	460	115	-	185	-	1/8	-	-	3.0	-	-	-	-	14.41	15	277/1		
8.12	430	110	-	175	-	1/8	-	-	3.0	-	-	-	-	14.41	15	277/1		
8.1	1400	350	-	560	-	1/3	-	-	9.0	-	-	-	-	15.53	20	480/3		
8.2	1010	255	-	405	-	1/3	-	-	6.5	-	-	-	-	11.77	15	480/3		
8.3	1720	430	-	690	-	1/3	-	-	11.0	-	-	-	-	19.04	20	480/3		
8.4	1350	325	-	520	-	1/3	-	-	9.0	-	-	-	-	15.53	20	480/3		
8.5	1500	375	-	600	-	1/3	-	-	10.0	-	-	-	-	17.04	20	480/3		
8.6	560	140	-	225	-	1/8	-	-	3.5	-	-	-	-	16.67	20	277/1		
8.7	820	205	-	330	-	1/8	-	-	5.5	-	-	-	-	25.69	30	277/1		
8.8	540	135	-	220	-	1/8	-	-	3.5	-	-	-	-	16.67	20	277/1		
8.9	1110	200	-	445	-	1/3	-	-	6.5	-	-	-	-	11.77	15	480/3		
8.10	1090	275	-	440	-	1/3	-	-	7.0	-	-	-	-	12.52	15	480/3		
8.11	740	185	-	300	-	1/8	-	-	5.0	-	-	-	-	23.44	25	277/1		
8.12	1050	255	-	420	-	1/3	-	-	6.5	-	-	-	-	11.77	15	480/3		
8.13	300	75	-	120	-	1/8	-	-	2.0	-	-	-	-	9.90	15	277/1		
8.14	1680	420	-	675	-	1/3	-	-	11.0	-	-	-	-	18.54	20	480/3		

(a) INCHES WG

S3008A

FAN SCHEDULE (EXISTING SCHEDULE)													
FAN #	LOCATION	SERVICE	CFM	ESP	MAX BHP	MAX HP	RPM	MAX SONES	MAX WEIGHT (#)	ELECTRICAL VOLT / PH	CONTROL	MANUFACTURER AND MODEL	REMARKS
F-1	DAY ROOM B111	CELLS/SHOWERS/TOIL	1640	.75	-	3/4	-	-	-	120/1	-	-	INLINE
F-2	DAY ROOM B135	CELLS/SHOWERS/TOIL	1640	.75	-	3/4	-	-	-	120/1	-	-	INLINE
F-3	CORRIDOR B103	JAN/ELECT/TOIL	400	.25	-	1/4	-	-	-	120/1	-	-	INLINE
F-4	SHOWER B163	SHOWER/TOIL	780	.50	-	1/4	-	-	-	120/1	-	-	INLINE
F-5	SHOWER B173	SHOWER/TOIL	780	.50	-	1/4	-	-	-	120/1	-	-	INLINE
F-6	SHOWER B182	SHOWER/TOIL	780	.50	-	1/4	-	-	-	120/1	-	-	INLINE
SEF-1		SMOKE EXHAUST	15,000	.50	-	5	-	-	-	460/3	-	-	INLINE
SEF-2		SMOKE EXHAUST	15,000	.50	-	5	-	-	-	460/3	-	-	INLINE
SEF-3		SMOKE EXHAUST	15,000	.50	-	5	-	-	-	460/3	-	-	INLINE
SEF-4		SMOKE EXHAUST	15,000	.50	-	5	-	-	-	460/3	-	-	INLINE
SEF-5		SMOKE EXHAUST	15,000	.50	-	5	-	-	-	460/3	-	-	INLINE
SEF-6		SMOKE EXHAUST	15,000	.50	-	5	-	-	-	460/3	-	-	INLINE
SEF-7		SMOKE EXHAUST	15,000	.50	-	5	-	-	-	460/3	-	-	INLINE
SEF-8		SMOKE EXHAUST	30,000	1.0	-	15	-	-	-	460/3	-	-	INLINE

9/20

S3201

Principal in Charge: DER

Project Engineer: JEB

Drawn By: JEB

Revisions:

No.	Date	Description

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YORK COUNTY PRISON  
HVAC RENOVATIONS  
HVAC SCHEDULES (EXISTING)

Project Title:

Sheet Title:

**Buford Goff & Associates, Inc.**  
Engineers & Planners

1331 Elmwood Ave.  
Suite 200  
Columbia, SC 29201  
Phone: (803) 254 - 6302

Sheet Number:

**M-301**

Date: 08-18-2023  
Scale: As Noted  
BGA Project Number: 22031  
CONSTRUCTION DOCUMENTS

SINGLE PACKAGE AIR CONDITIONING UNIT SCHEDULE - VARIABLE AIRFLOW																													
AIR CONDITIONER #	LOCATION	ESP (a)	CFM			FANS				COMPRESSOR		GAS HEAT			COOLING COIL CAPACITY						WEIGHT (#)	ELECTRICAL			MANUFACTURER AND MODEL	REMARKS			
			TOTAL	OA	MIN	OUTDOOR		INDOOR		NO	RLA	CFH INPUT	MBH OUTPUT	IN WG	MBH (NET)		OUTDOOR DB T		ENT AIR			LEAVING AIR		EER			MCA	MOCP	VOLT / PH
						FLA	NO	BHP	HP						TOTAL	SENS	DB	WB	DB	WB									
SPAC-8.9	ADMIN. WING	2.5	12,000	2300	3600	-	4	13.3	20	3	15.6/25.4	400	324	7-14	437.0	291.6	95	78.8	66.5	53.2	53.2	11.2	7000	113	125	460/3	TRANE YCH480	①②③④⑤⑥⑦⑧⑨⑩⑪	

(a) INCHES WG  
 ① UNIT ON GRADE    ③ SUPPLY FAN VFDS    ⑤ DISCONNECT SWITCH    ⑦ 0-100% MODULATING, LOW LEAK OA DAMPER CONTROLLABLE BY BMS.    ⑨ DIRECT DRIVE MOTOR    ⑪ AIRFLOW MEASURING STATION IN THE OUTSIDE AIR HOOD BY CONTROLS CONTRACTOR  
 ② HORIZONTAL DISCHARGE    ④ 5 STAGES OF COOLING MIN    ⑥ SINGLE POINT CONNECTION    ⑧ 2-POSITION, LOW LEAK RETURN DAMPER CONTROLLABLE BY BMS.    ⑩ MODULATING GAS HEAT 10:1 TURNDOWN

SINGLE PACKAGE AIR CONDITIONING UNIT SCHEDULE - CONSTANT AIRFLOW																													
AIR CONDITIONER #	LOCATION	ESP (a)	CFM			FANS				COMPRESSOR		GAS HEAT			COOLING COIL CAPACITY						WEIGHT (#)	ELECTRICAL			MANUFACTURER AND MODEL	REMARKS			
			TOTAL	OA	MIN	OUTDOOR		INDOOR		NO	RLA	CFH INPUT	MBH OUTPUT	IN WG	MBH (NET)		OUTDOOR DB T		ENT AIR			LEAVING AIR		EER			MCA	MOCP	VOLT / PH
						FLA	NO	BHP	HP						TOTAL	SENS	DB	WB	DB	WB									
SPAC-1.2	DORMS	0.75	3,000	350	350	1.5	1	1.3	3.1	1/1	8.2/4.3	150	121.5	7-14	87.9	68.0	95	77.3	65.0	55.4	54.8	12.1	1100	21	25	460/3	TRANE YHJ090	①②③④⑤⑥⑦⑧⑨⑩⑪	
SPAC-3.4	DAYROOM/CELLS	1.25	5000	1320	-	2	3.8	-	1/1	14.6/6.5	200	162	7-14	146.9	105.8	95	80.3	67.9	58.9	58.0	10.8	1500	33	45	460/3	TRANE YHJ150	①②③④⑤⑥⑦⑧⑨⑩⑪		
SPAC-5.6.7	DORMS	1.25	6000	1000	-	2	2.7	3.1	1/1	16.7/8.2	250	202.5	7-14	178.5	134.1	95	78.3	66.0	56.6	55.8	11.9	2200	41	50	460/3	TRANE YHJ180	①②③④⑤⑥⑦⑧⑨⑩⑪		

(a) INCHES WG  
 ① UNIT ON GRADE    ③ SUPPLY FAN VFDS    ⑤ DISCONNECT SWITCH    ⑦ 0-100% MODULATING, LOW LEAK OA DAMPER CONTROLLABLE BY BMS.    ⑨ MODULATING HOT GAS REHEAT TO 72 DEG F    ⑪ AIRFLOW MEASURING STATION IN THE OUTSIDE AIR HOOD BY CONTROLS CONTRACTOR  
 ② HORIZONTAL DISCHARGE    ④ 2 STAGE GAS HEAT    ⑥ SINGLE POINT CONNECTION    ⑧ 2-POSITION, LOW LEAK RETURN DAMPER CONTROLLABLE BY BMS.    ⑩ DIRECT DRIVE MOTOR

SPLIT SYSTEM AIR CONDITIONING UNIT SCHEDULE - DUCTLESS																													
INDOOR UNIT												OUTDOOR UNIT										COOLING COIL CAPACITY						REMARKS	
INDOOR AC #	LOCATION	CFM		ESP(a)	FLA	WEIGHT (#)	ELECTRICAL			MANUFACTURER AND MODEL	OUTDOOR AC #	FANS		COMPRESSOR		ELECTRICAL			MANUFACTURER AND MODEL	MBH (NET)		OUTDOOR DB T		ENT AIR		LVG AIR			SEER
		TOTAL	OA				MCA	MOCP	VOLT / PH			FLA	NO	NO	RLA	WEIGHT (#)	MCA	MOCP		VOLT / PH	TOTAL	SENS	DB	WB	DB	WB	DB		
IDAC-1	SEC/ELECT B104	400	-			25	1.4	-	-	mitsubishi ntxwmt09	ODAC-1	0.7	1	1	8.8	80	12	15	120/1	mitsubishi ntxsmt09	9.1	7.4	95	80	67	-	-	17	①②③④⑤⑥⑦

\* INCLUDES DUCT, GRILLES, AND LOADED FILTERS; (a) INCHES WG; (b) @ ARI CONDITIONS  
 ① LOW AMBIENT CONTROL TO 20°F    ③ FACTORY MOUNTED CONDENSATE PUMP    ⑤ INVERTER COMPRESSOR    ⑦ HARD WIRED THERMOSTAT  
 ② R410A REFRIGERANT    ④ POWER INDOOR UNIT FROM OUTDOOR UNIT    ⑥ WALL MOUNTED INDOOR UNIT

SPLIT SYSTEM HEAT PUMP SCHEDULE																																					
INDOOR UNIT												OUTDOOR UNIT										SYSTEM						REMARKS									
INDOOR UNIT #	LOCATION	CFM		ESP(a)	FLA	ELECTRIC HEAT		WEIGHT (#)	ELECTRICAL			MANUFACTURER AND MODEL	OUTDOOR UNIT #	FANS		COMPRESSOR		ELECTRICAL			MANUFACTURER AND MODEL	MBH (NET)		OUTDOOR DB T		HEATING COIL CAPACITY @ 17 F			HEATING COIL CAPACITY @ 47 F		HSPF						
		TOTAL	OA			KW	VOLT / PH		MCA	MOCP	VOLT / PH			HP	NO	NO	RLA	WEIGHT (#)	MCA	MOCP		VOLT / PH	TOTAL	SENS	DB	WB	DB		WB	SEER (b)		ENT DB T	MBH	COP	MBH	COP	
IDHP-2	CONTROL ROOM B101	800	100	0.4	2.8	5.8	208/1	150	38	40	208/1	TRANE TEM480B24	ODHP-2	0.125	1	1	11.5	250	15	25	208/1	TRANE 4TWR4024	23.9	17.9	95	80	67	59	57.2	14.3	70	14.6	2.6	22.6	4.0	7.5	①②③④⑤⑥⑦⑧

\* INCLUDES DUCT, GRILLES, AND LOADED FILTERS; (a) INCHES WG; (b) @ ARI CONDITIONS  
 ① PROVIDE START CAPACITOR FOR SINGLE PHASE UNITS    ③ DIRECT DRIVE MOTOR    ⑤ R410A REFRIGERANT    ⑦ MERV 8 FILTER  
 ② LOW AMBIENT CONTROL TO 20°F    ④ 1 PT POWER CONNECTION ON INDOOR UNIT    ⑥ AUXILIARY DRAIN PAN    ⑧ DEHUMIDIFICATION CONTROL MODULE

BIPOLAR IONIZATION SYSTEM SCHEDULE											
IONIZATION UNIT #	LOCATION	CFM		SPACE (b)		PEOPLE	STEADY STATE CONCENTRATIONS (a)		ELECT VOLT	MANUFACTURER AND MODEL	REMARKS
		TOTAL	OA	AREA	HT.		CO <sub>2</sub>	NH <sub>4</sub>			
BP-#	IDHP-2	1200	-	-	-	-	<1800	<10	24 VAC/VDC	GPS CI-2	②③
BP-#	SPAC-1.4	<5100	-	-	-	-	<1800	<10	24 VAC/VDC	GPS FC48	②③
BP-#	SPAC-5.9	>5100	-	-	-	-	<1800	<10	24 VAC/VDC	GPS FC48	④ ②③

(a) PPM AT 300 MINUTES OPERATION    ① PROVIDE FOR ALL UNITS ON THE PROJECT    ③ AUTO-CLEANING  
 (b) MIN. SPACE SIZE. ACTUAL SPACE MAY BE LARGER.    ② COORDINATE LOCATIONS AND POWER WITH EQUIPMENT MANUFACTURER    ④ PROVIDE MULTIPLE UNITS (MIN OF TWO)

Principal in Charge: DER

Project Engineer: JEB

Drawn By: JEB

Revisions:		
No.	Date	Description

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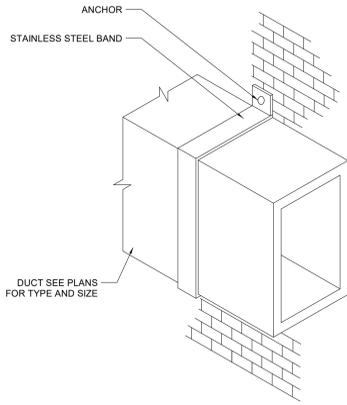


YORK COUNTY PRISON  
 HVAC RENOVATIONS  
 HVAC SCHEDULES


Project Title:  
 Sheet Title:

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Sheet Number:  
**M-302**  
 Date: 08-18-2023  
 Scale: As Noted  
 BGA Project Number: 22031  
 CONSTRUCTION DOCUMENTS



HORIZONTAL DUCT SUPPORT

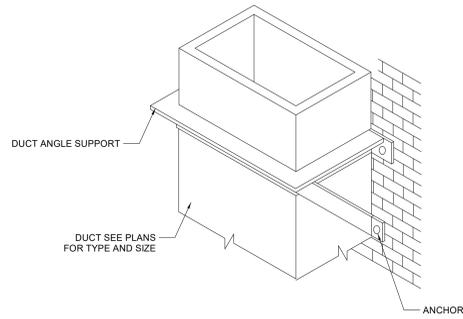


VERTICAL DUCT SUPPORT

**NOTES:**

1. PROVIDE BRACKETS EVERY 10 FEET (MAX) AND WITHIN 12 INCHES OF AN ELBOW.
2. LOCATE DUCT AGAINST WALL OR MAXIMUM OF 2 INCHES FROM THE WALL.
3. ANCHORS AND DUCT SUPPORTS SHALL BE DESIGNED FOR WIND AND SEISMIC LOADS.
4. ATTACH DUCT TO SUPPORT PER SMACNA.


**DUCT SUPPORT FROM WALL DETAIL**  
NOT TO SCALE

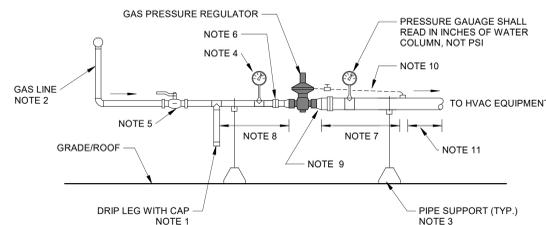


**NOTES:**

1. DRIP LEG TO BE A MIN. OF 6".
2. ALL GAS PIPING SHALL BE PAINTED. SEE PLANS FOR ROUTING.
3. ALL PIPE SUPPORTS SHALL BE GALVANIZED.
4. PRESSURE GAUGE SHALL READ IN PSI.
5. GAS BALL VALVE FOR SHUT-OFF. VALVE SHALL BE WITHIN 6'-0" OF THE EQUIPMENT.
6. UNION (TYP.)
7. PROVIDE 8 TO 10 PIPE DIAMETERS DOWNSTREAM OF THE REGULATOR PRIOR TO FITTINGS OR UNIT CONNECTION.
8. PROVIDE 3 TO 5 PIPE DIAMETERS UPSTREAM OF THE REGULATOR PRIOR TO ANY FITTINGS.
9. PROVIDE CONCENTRIC REDUCERS TO CONNECT TO THE REGULATOR. IF THE REGULATOR OUTLET SIZE IS MORE THAN 2 NOMINAL PIPE SIZES SMALLER THAN THE LINE SIZE, PROVIDE DOWNSTREAM SENSING LINE.
10. IF REQUIRED, THE SENSING LINE SHALL BE A MINIMUM OF 3/8" AND BE MADE OF STAINLESS STEEL OR COPPER TUBING. SLOPE THE SENSING LINE TOWARD THE TAP. PROVIDE WEGATE OR MULTITURN VALVE IN THE CONTROL LINE.
11. IF A SENSING LINE IS PROVIDED, LOCATE THE SENSING LINE TAP ON TOP OF THE PIPE. TAP SHOULD BE 10 PIPE DIAMETERS AFTER ANY REDUCERS AND 3 TO 5 PIPE DIAMETERS BEFORE THE EQUIPMENT. INSTALL PRESSURE GAUGE DOWNSTREAM OF THE TAP.

**GAS REGULATOR PIPING DETAIL**  
NOT TO SCALE

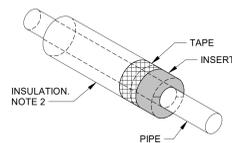

RIGID INSERT FOR ELASTOMERIC INSULATION (HANGERS AND CLAMPS)

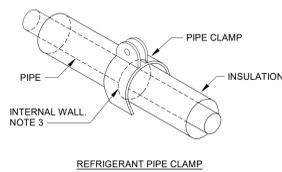


REFRIGERANT PIPE CLAMP

**NOTES:**

1. RIGID INSULATION INSERT SHALL OCCUR AT EVERY HANGER OR PIPE CLAMP UNLESS A REFRIGERANT PIPE CLAMP IS USED.
2. INSULATION SHALL BUTT UP TIGHT TO INSERT. SEAL WITH MANUFACTURER'S TAPE TO PROVIDE AN AIRTIGHT SEAL.
3. INSERT INSULATION INTO THE PIPE CLAMP POCKETS ON BOTH SIDES UP TO THE INTERNAL WALL TO CREATE A CONTINUOUSLY INSULATED ASSEMBLY. SEAL AROUND CLAMP WITH MANUFACTURER'S APPROVED TAPE.


**REFRIGERANT PIPE CLAMP DETAIL**  
3183 NOT TO SCALE 10/22

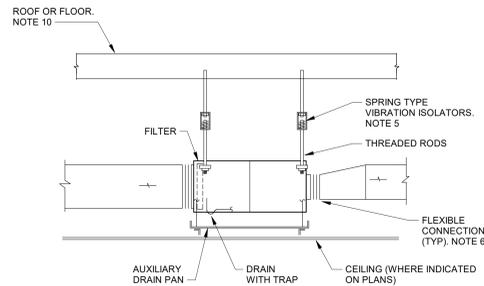


**NOTES:**

1. SUPPORT FROM OTHER ROOF TYPES OR SLABS SIMILARLY.
2. TRANSITION SUPPLY AND RETURN DUCT AS REQUIRED FOR CONNECTION TO AIR HANDLER.
3. PROVIDE MANUFACTURER'S RECOMMENDED CLEARANCE FOR MAINTENANCE OR CLEARANCE INDICATED ON PLANS, WHICHEVER IS GREATER.
4. MOUNT UNIT TO MAINTAIN SLOPE ON DRAIN LINE.
5. SPRING ISOLATORS REQUIRED WHERE SPECIFIED.
6. FLEX CONNECTION FOR ALL UNITS WITH MOTORS.
7. PROVIDE A FACTORY INSTALLED FILTER HOUSING WITH SIDE OR BOTTOM ACCESS AS REQUIRED.
8. AUXILIARY DRAIN PAN REQUIRED ON ALL EQUIPMENT WITH COOLING COIL OR WHERE CONDENSATION IS POSSIBLE, WHEN UNIT LOCATED ABOVE CEILING, IN ATTIC, OR SIMILAR LOCATION.
9. THREADED RODS FOR AUXILIARY DRAIN PAN CAN BE THE SAME AS THE UNIT SUPPORT RODS IF THEY CAN BE PROPERLY INSTALLED (I.E. WITHOUT BENDING, INTERFERING WITH UNIT ACCESS, ETC.). OTHERWISE THEY SHALL BE RUN SIMILAR TO UNIT SUPPORT RODS.
10. SEE ARCHITECTURAL AND STRUCTURAL PLANS FOR ROOF OR FLOOR CONSTRUCTION.

**SUSPENDED INDOOR AIR HANDLING EQUIPMENT DETAIL**  
3016 NOT TO SCALE 01/15

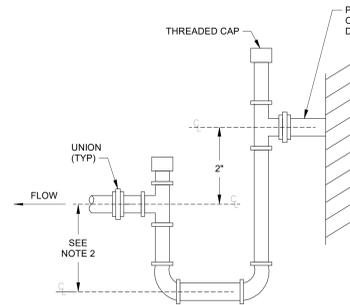

BLOW THRU DRAIN

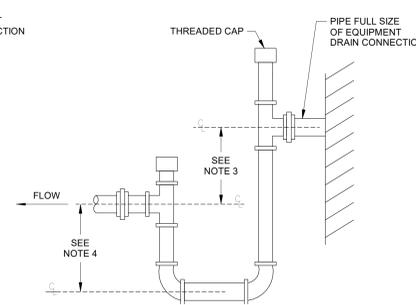


DRAW THRU DRAIN


**NOTES:**

1. LOCATE TRAPS SO AS TO BE ACCESSIBLE FOR CLEANING.
2. HEIGHT SHALL BE EQUAL TO UNIT MAXIMUM TOTAL STATIC PRESSURE PLUS 1/2".
3. HEIGHT SHALL BE EQUAL TO UNIT MAXIMUM NEGATIVE STATIC PRESSURE PLUS 1".
4. HEIGHT SHALL BE 1/2 OF HEIGHT INSTALLED IN NOTE 3.
5. PIPE TO NEAREST DRAIN.
6. TRAP SHALL NOT BLOCK ACCESS TO EQUIPMENT.
7. PROVIDE UNIONS AT INLET AND OUTLET OF TRAP.
8. DRAIN LINE SHALL BE 3/4" MIN OR UNIT CONNECTION SIZE, WHICHEVER IS LARGER.

**EQUIPMENT CONDENSATE DRAIN DETAIL**  
3179B NOT TO SCALE 03/16

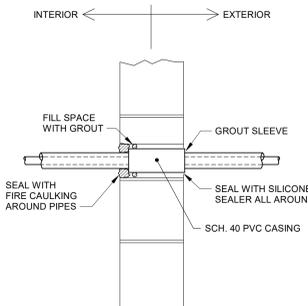


**REFRIGERANT PIPE THROUGH WALL DETAIL**  
3177B NOT TO SCALE 04/12

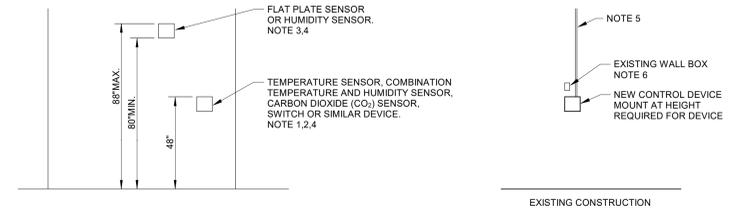

**NOTES:**

1. DEVICES THAT REQUIRE ACCESS BY BUILDING OCCUPANTS OTHER THAN MAINTENANCE PERSONNEL.
2. 44" TO TOP OF DEVICE WHEN OBSTACLE (SHELVING, COUNTER, ETC.) IN FRONT OF DEVICE.
3. DEVICES THAT DO NOT REQUIRE ACCESS BY BUILDING OCCUPANTS OTHER THAN MAINTENANCE PERSONNEL.
4. HEIGHT SHALL BE AS INDICATED UNLESS A DEVICE IS SPECIFICALLY REQUIRED TO BE LOCATED AT ANOTHER HEIGHT TO PERFORM ITS INTENDED FUNCTION.
5. PROVIDE WIRE MOLD WHERE PERMITTED ON EXISTING WALL WHERE CONTROLS CANNOT BE INSTALLED IN THE WALL.
6. PROVIDE OVERSIZED STAINLESS STEEL COVER PLATE IF BOX IS NOT REUSED.


**DEVICE MOUNTING HEIGHT DETAIL**  
3714 NOT TO SCALE 02/18

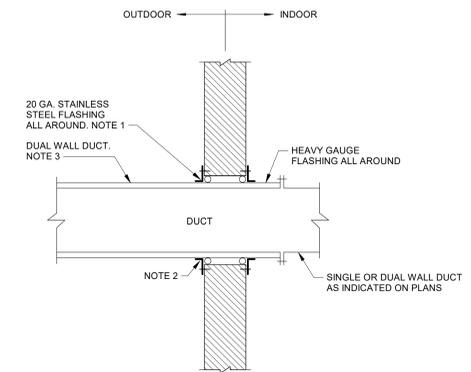

**NOTES:**

1. PROVIDE CAULKING BEHIND ANGLE.
2. PROVIDE SEALANT BETWEEN DUCT AND WALL ALL AROUND.
3. SEE SPECIFICATIONS

**DUAL WALL DUCT THROUGH EXTERIOR WALL DETAIL**  
3041C NOT TO SCALE 10/09

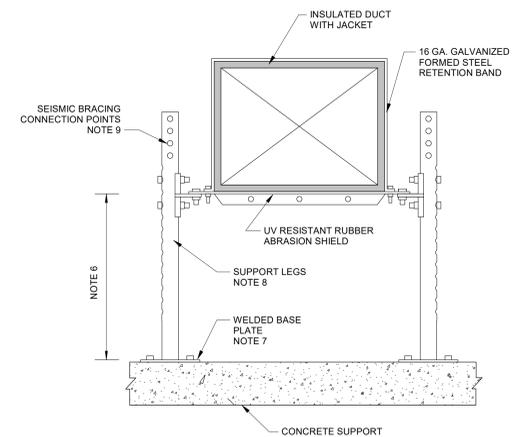

**NOTES:**

1. PROVIDE PRE-ENGINEERED GRADE MOUNTED DUCT SUPPORT SYSTEM. SYSTEM SHALL BE SIZED FOR THE PROPER DUCT DIMENSIONS, WEIGHTS, AND SEISMIC/WIND LOADS. MECHANICAL SUPPORT SYSTEMS, INC. NO. 101-G OR APPROVED EQUAL.
2. RUN INSULATION AND JACKETING CONTINUOUSLY THROUGH SUPPORTS.
3. ALL STRUCTURAL SUPPORTS AND ACCESSORIES SHALL BE HOT DIPPED GALVANIZED.
4. SEE PLAN FOR SPACING OF SUPPORTS. WHERE SPACING IS NOT SHOWN, PROVIDE SUPPORTS A MINIMUM EVERY 8 FEET.
5. OPTIONAL UNDER PIPE RACK SUPPORT RACK MAY BE USED TO SUPPORT PIPING AS REQUIRED.
6. ADJUST HEIGHT AS REQUIRED FOR INSTALLATION. MIN 12" AFG.
7. ATTACH BASE PLATES TO CONCRETE SUPPORT PER THE SEISMIC/WIND SUBMITTAL.
8. SCHEDULE 40 PIPE OR UNISTRUT SUPPORT LEGS. LEGS SHALL ALLOW ADJUSTMENT IN INCREMENTS OF 3/4".
9. PROVIDE SEISMIC BRACING WHEN REQUIRED FOR THE SEISMIC OR WIND LOADING CONDITIONS.

**OUTDOOR DUCT SUPPORTS**  
NOT TO SCALE

Principal in Charge: DER

Project Engineer: JEB

Drawn By: JEB

Revisions:		
No.	Date	Description

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YORK COUNTY PRISON  
HVAC RENOVATIONS

HVAC DETAILS

Project Title:

Sheet Title:

**Buford Goff & Associates, Inc.**  
Engineers & Planners

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Sheet Number:

**M-400**

Date: 08-18-2023  
Scale: As Noted  
BGA Project Number: 22031  
CONSTRUCTION DOCUMENTS


Project Engineer:  
ECW  
 Drawn By:  
GMC  
 Revisions:  
 No. \_\_\_\_\_ Date \_\_\_\_\_  
 No. \_\_\_\_\_ Date \_\_\_\_\_  
 No. \_\_\_\_\_ Date \_\_\_\_\_  
 No. \_\_\_\_\_ Date \_\_\_\_\_  
 No. \_\_\_\_\_ Date \_\_\_\_\_  
 No. \_\_\_\_\_ Date \_\_\_\_\_  
 No. \_\_\_\_\_ Date \_\_\_\_\_

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ELECTRICAL SYMBOL SCHEDULE	
SYMBOL	DESCRIPTION
	20A, 125V, GFCI WET LOCATION DUPLEX RECEPTACLE. PROVIDE CAST WEATHER-PROOF, METAL BACKBOX.
	JUNCTION BOX, SIZE PER NEC UNLESS SIZE NOTED
	FUSED DISCONNECT SWITCH. SIZE FUSES PER NAME PLATE MOP.
	120/240V OR 120/208V PANELBOARD
	277/480V PANELBOARD
	CONDUIT RUN OVERHEAD
	CONDUIT RUN UNDERGROUND
	HVAC UNIT TO BE DEMOLISHED. NOTE 1.
AFF	ABOVE FINISHED FLOOR
C.	CONDUIT
CB	CONDUIT BREAKER
RT	RAINTIGHT, NEMA 3R
MOP	MAXIMUM OVERCURRENT PROTECTION
	KEYNOTE LABEL
x	EQUIPMENT CONNECTION
	SEALTIGHT FLEX CONNECTION TO MOTOR LOAD

**SYMBOL LEGEND NOTES:**  
 1. FOR MECHANICAL EQUIPMENT SHOWN TO BE DEMOLISHED, REMOVAL OF MECHANICAL EQUIPMENT IS UNDER DIVISION 23 SCOPE. DIVISION 26 SCOPE SHALL INCLUDE DISCONNECTION AND REMOVAL OF ELECTRICAL SERVICE TO MECHANICAL EQUIPMENT. SEE SPECIFICATION 260502 FOR MORE DETAILED SCOPE OF DEMOLITION WORK.




1 AREA A - FLOOR PLAN - ELECTRICAL DEMOLITION  
 1/8" = 1'-0"

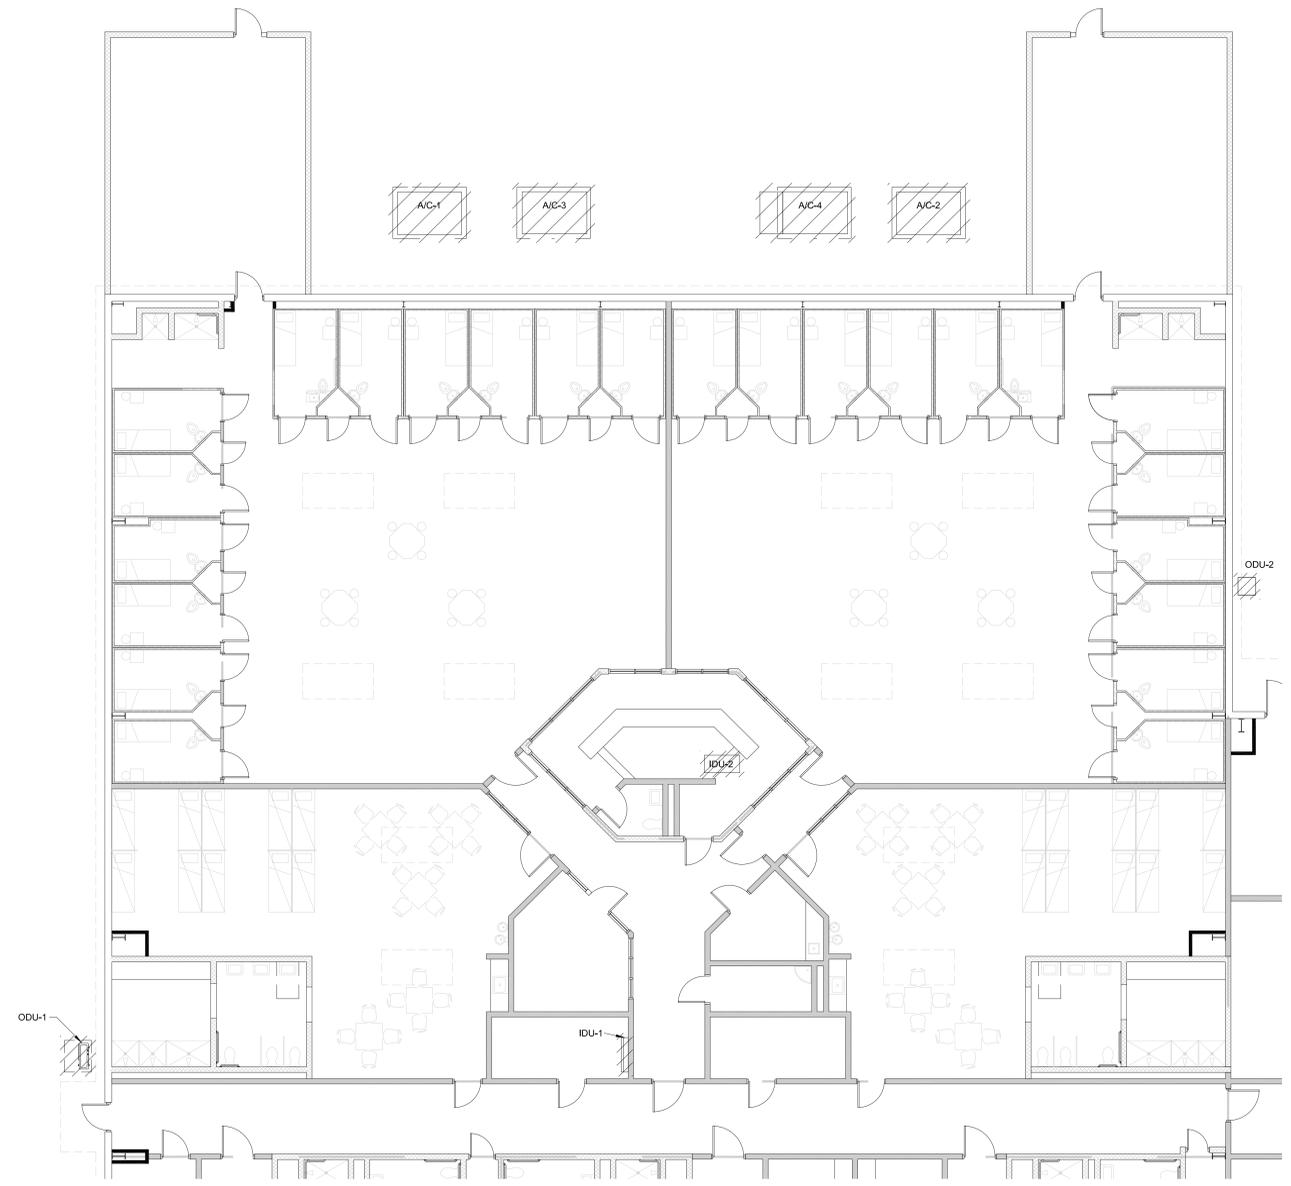Project: YORK COUNTY PRISON HVAC RENOVATIONS  
 Sheet Title: AREA A - FLOOR PLAN - ELECTRICAL DEMOLITION

**Buford Goff**  
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 Engineers & Planners  
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 Suite 200  
 Columbia, SC 29201  
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Sheet Number:  
**E-101**


Date: 08-18-2023  
 Scale: As Noted  
 BGA PROJECT NUMBER: 22031  
 CONSTRUCTION DOCUMENTS

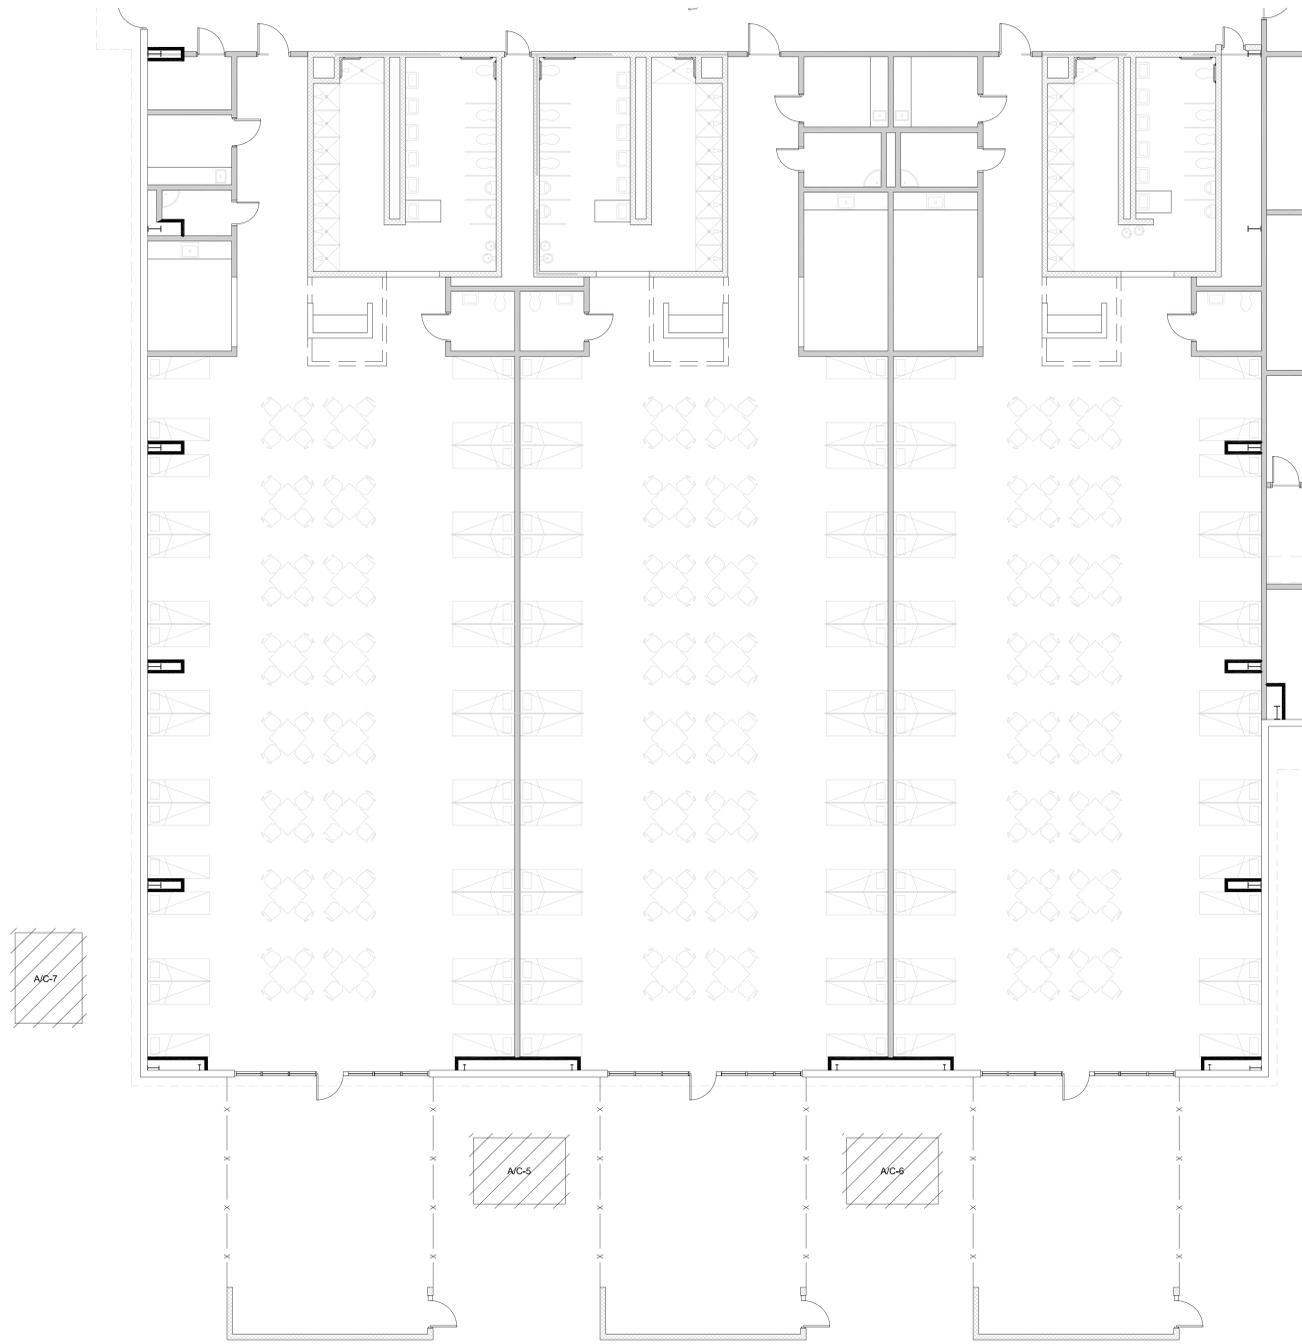

1 AREA B - FLOOR PLAN - ELECTRICAL DEMOLITION  
1/8" = 1'-0"

Project Engineer:	ECW
Drawn By:	GMC
Revisions:	
No.	Date
No.	Date
No.	Date
No.	Date
No.	Date
No.	Date
No.	Date
No.	Date

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Sheet Title: AREA B - FLOOR PLAN - ELECTRICAL DEMOLITION
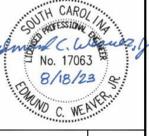
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Sheet Number:  
**E-102**  
Date: 08-18-2023  
Scale: As Noted  
BCA PROJECT NUMBER: 22031  
CONSTRUCTION DOCUMENTS



1 AREA C - FLOOR PLAN - ELECTRICAL DEMOLITION  
1/8" = 1'-0"

Project Engineer:	ECW
Drawn By:	GMC
Revisions:	
No. _____	Date _____
No. _____	Date _____
No. _____	Date _____
No. _____	Date _____
No. _____	Date _____
No. _____	Date _____
No. _____	Date _____

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Sheet Title: AREA C - FLOOR PLAN - ELECTRICAL DEMOLITION

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Sheet Number:  
**E-103**

Date: 08-18-2023  
Scale: As Noted  
BCA PROJECT NUMBER: 22031  
CONSTRUCTION DOCUMENTS

Project Engineer:  
ECW  
 Drawn By:  
GMC

Revisions:

No.	Date	
No.	Date	
No.	Date	
No.	Date	
No.	Date	
No.	Date	
No.	Date	

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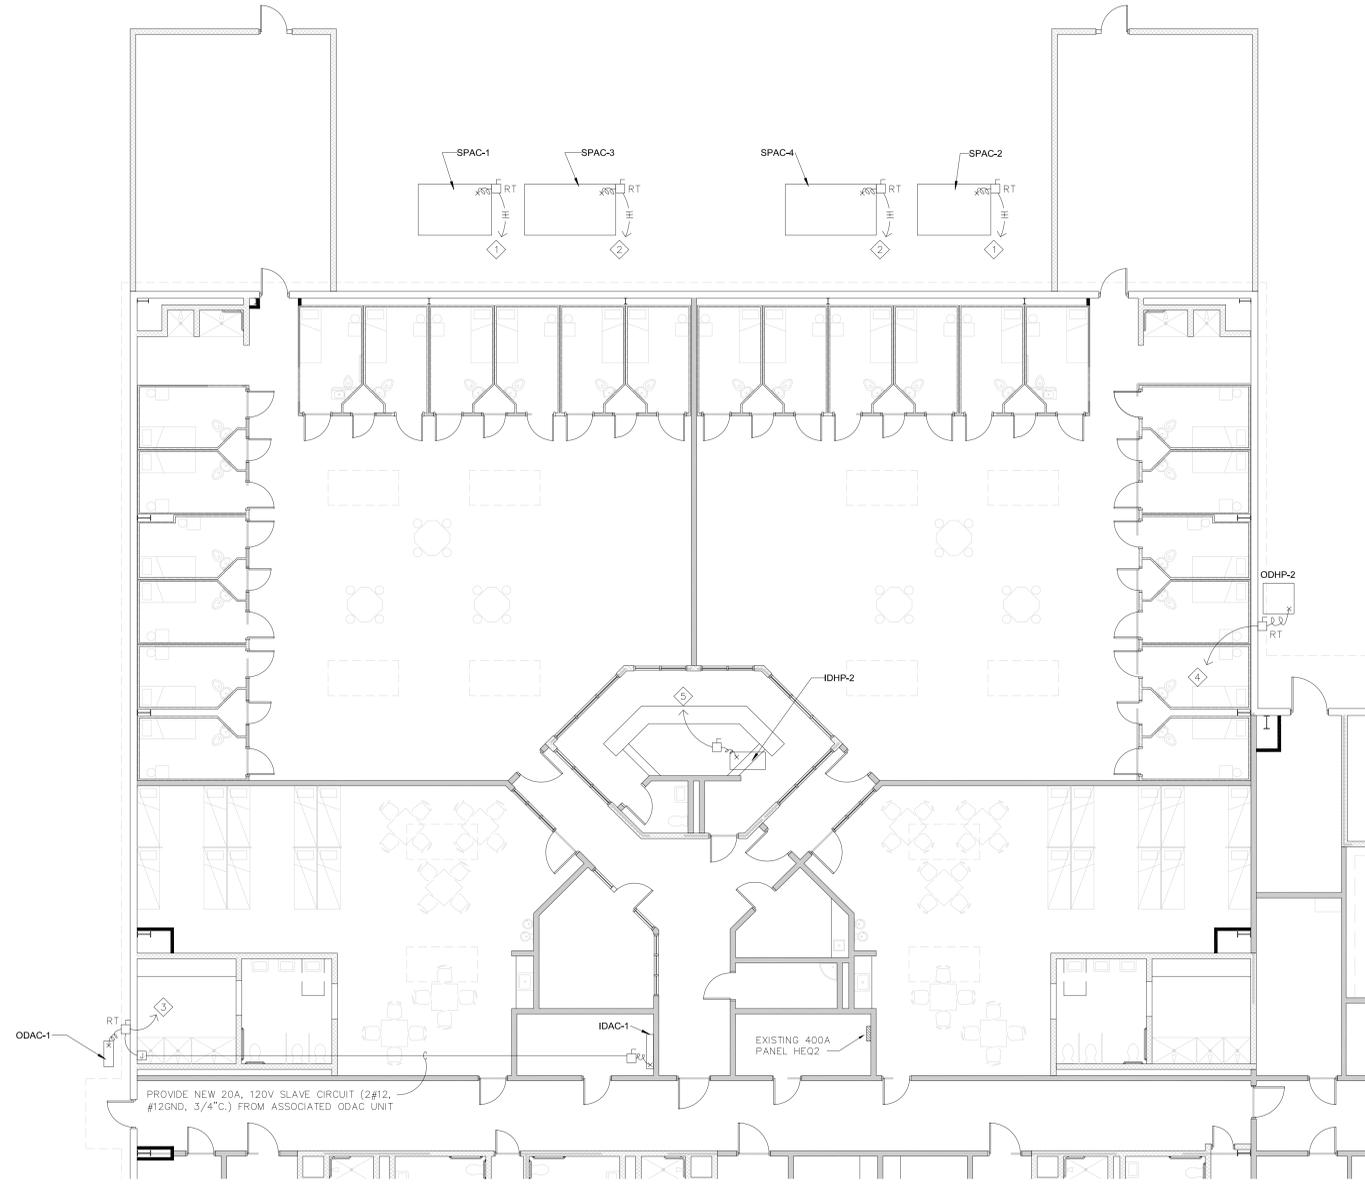
YORK COUNTY PRISON HVAC RENOVATIONS  
 AREA A - FLOOR PLAN - ELECTRICAL RENOVATION

Project  
Sheet Title

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Sheet Number:  
**E-201**  
 Date: 08-18-2023  
 Scale: As Noted  
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- KEYNOTES:**
- RECONNECT/EXTEND EXISTING 25A, 480V, 3PH, 3W BRANCH CIRCUIT (3#10, #10GND, 1" C.) TO NEW SPAC UNIT. PROVIDE NEW 1" CONDUIT (MATCH EXISTING) AND NEW WIRING. PROVIDE WATER-TIGHT SPLICE/J-BOX AS REQUIRED.
  - RECONNECT/EXTEND EXISTING 40A, 480V, 3PH, 3W BRANCH CIRCUIT (3#8, #10GND, 1" C.) TO NEW SPAC UNIT. PROVIDE NEW 1" CONDUIT (MATCH EXISTING) AND NEW WIRING. PROVIDE WATER-TIGHT SPLICE/J-BOX AS REQUIRED.
  - RECONNECT/EXTEND EXISTING 15A, 208V, 1PH, 2W BRANCH CIRCUIT (2#12, #12GND, 3/4" C.) TO NEW ODAC UNIT. PROVIDE NEW 3/4" CONDUIT (MATCH EXISTING) AND NEW WIRING. PROVIDE WATER-TIGHT SPLICE/J-BOX AS REQUIRED. NEW ODAC UNIT IS 120V. REPLACE EXISTING 15A, 2P CB IN PANEL LEQ WITH TWO NEW 15A, 1P CB'S.
  - RECONNECT/EXTEND EXISTING 20A, 208V, 1PH, 2W BRANCH CIRCUIT (2#12, #12GND, 3/4" C.) TO NEW ODHP UNIT. PROVIDE NEW 3/4" CONDUIT (MATCH EXISTING) AND NEW WIRING. PROVIDE WATER-TIGHT SPLICE/J-BOX AS REQUIRED. REPLACE EXISTING 20A, 2P CB IN PANEL LEQ WITH NEW 25A, 2P CB.
  - RECONNECT/EXTEND EXISTING 40A, 208V, 1PH, 2W BRANCH CIRCUIT (2#8, #10GND, 1" C.) TO NEW IDHP UNIT. PROVIDE NEW 3/4" CONDUIT (MATCH EXISTING) AND NEW WIRING.




**1** AREA A - FLOOR PLAN - ELECTRICAL RENOVATION  
 1/8" = 1'-0"

PROVIDE NEW 20A, 120V SLAVE CIRCUIT (2#12, #12GND, 3/4" C.) FROM ASSOCIATED ODAC UNIT

EXISTING 400A PANEL HE02

KEYNOTES:  
 1 RECONNECT/EXTEND EXISTING 50A, 480V, 3PH, 3W BRANCH CIRCUIT (3#6, #10GND, 1" C.) TO NEW SPAC UNIT. PROVIDE NEW 1" CONDUIT (MATCH EXISTING) AND NEW WIRING. PROVIDE WATER-TIGHT SPLICE/J-BOX AS REQUIRED.

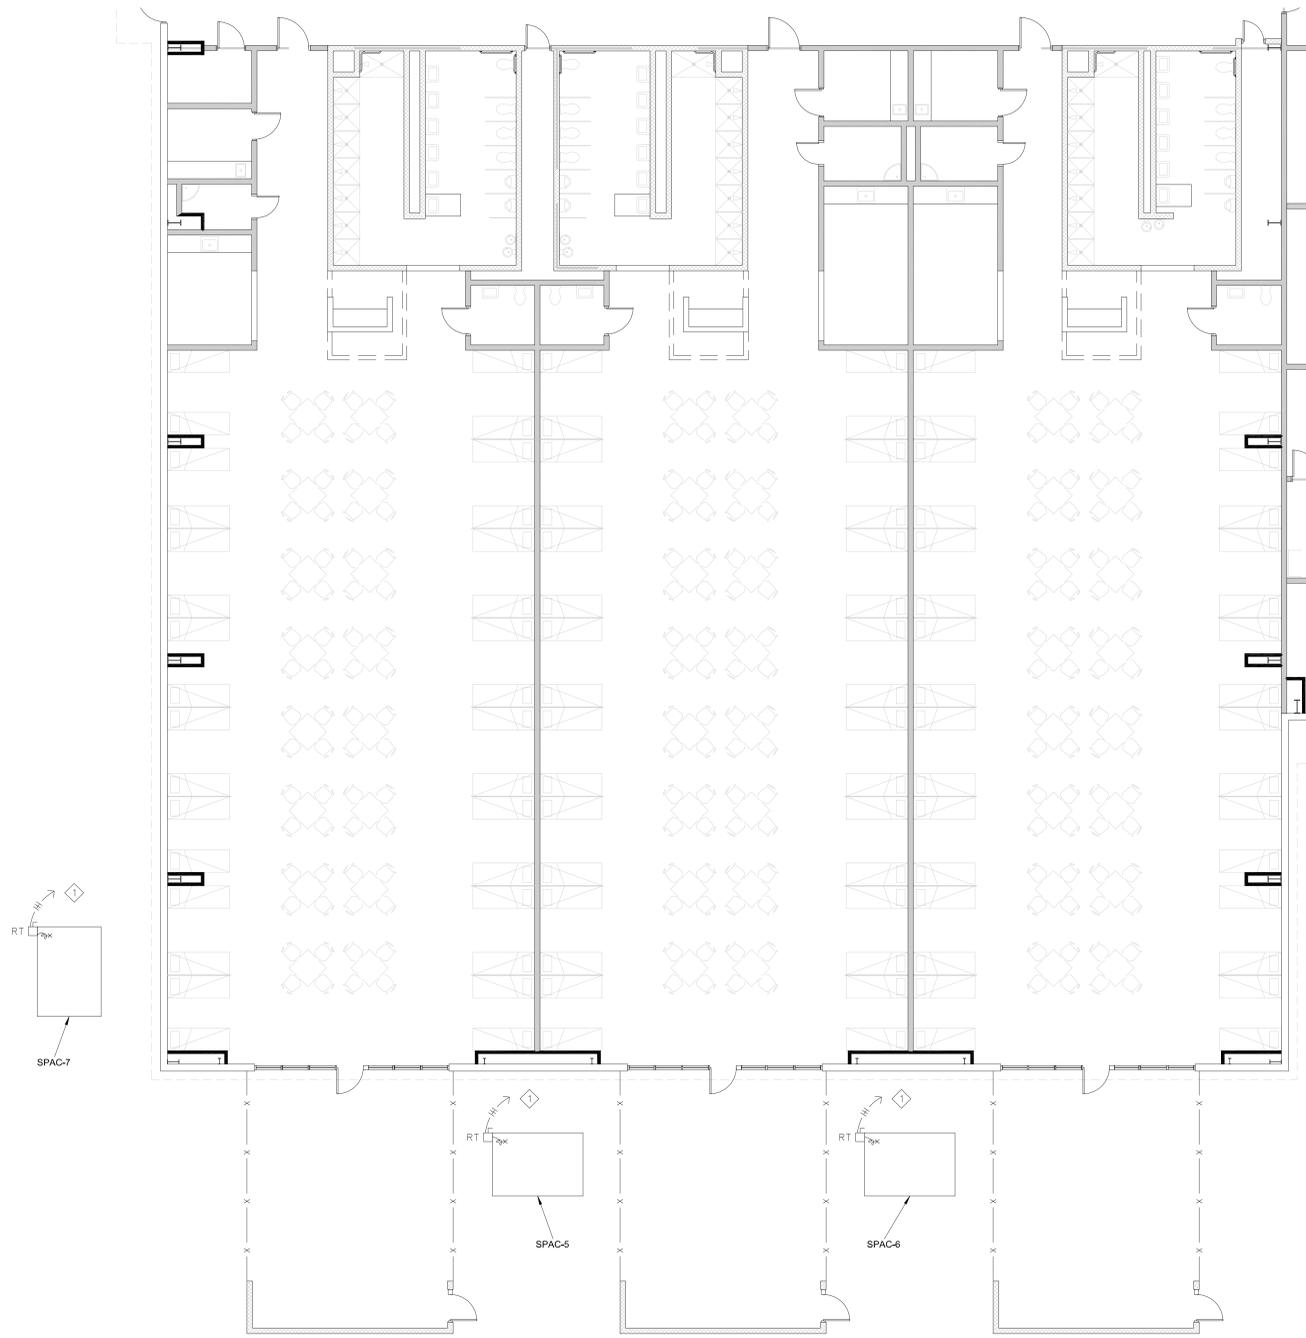

1 AREA B - FLOOR PLAN - ELECTRICAL RENOVATION  
 1/8" = 1'-0"

Project Engineer:	ECW
Drawn By:	GMC
Revisions:	
No. _____	Date _____
No. _____	Date _____
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Project: YORK COUNTY PRISON HVAC RENOVATIONS  
 Sheet Title: AREA B - FLOOR PLAN - ELECTRICAL RENOVATION

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Sheet Number:  
**E-202**  
 Date: 08-18-2023  
 Scale: As Noted  
 BGA PROJECT NUMBER: 22031  
 CONSTRUCTION DOCUMENTS

KEYNOTES:  
 1 RECONNECT/EXTEND EXISTING 125A, 480V, 3PH, 3W BRANCH CIRCUIT (3#1/0, #6GND, 2" C.) TO NEW SPAC UNIT. PROVIDE NEW 2" CONDUIT (MATCH EXISTING) AND NEW WIRING. PROVIDE WATER-TIGHT SPLICE/J-BOX AS REQUIRED.



1 AREA C - FLOOR PLAN - ELECTRICAL RENOVATION  
 1/8" = 1'-0"

Project Engineer:	ECW
Drawn By:	GMC
Revisions:	
No. _____	Date _____
No. _____	Date _____
No. _____	Date _____
No. _____	Date _____
No. _____	Date _____
No. _____	Date _____
No. _____	Date _____

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YORK COUNTY PRISON HVAC RENOVATIONS  
 AREA C - FLOOR PLAN - ELECTRICAL RENOVATION

Project  
 Sheet Title

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Sheet Number:  
**E-203**

Date: 08-18-2023  
 Scale: As Noted  
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